

LOCATION MAP

SALEM, MA

SWAMPSCOTT ROAD AT FIRST STREET ROUNDABOUT CONSTRUCTION

INDEX

SHEET NO.

30-32

33

34-36

TITLE SHEET AND INDEX LEGEND, ABBREVIATIONS AND GENERAL NOTES **KEY PLAN** EXISTING CONDITIONS PLANS TYPICAL SECTIONS CONSTRUCTION PLANS 10-11 **PROFILES CURB TIE PLANS** 12-14 15-17 GRADING PLANS 18 DRAINAGE PIPE & STRUCTURE SCHEDULE SIGN AND PAVEMENT MARKING PLANS 19-20 TRAFFIC SIGN SUMMARY TEMPORARY TRAFFIC CONTROL PLANS 28 LIGHTING GENERAL NOTES AND LEGEND 29 LIGHTING PLAN

LIGHTING DETAILS

CONSTRUCTION DETAILS

WHEELCHAIR RAMP DETAILS

DIAGRAM

LIGHTING PANEL SCHEDULES AND ONE LINE RISER

PROJECT LOCATION

Radio Tower

VICINITY MAP 1" = 1000'

CITY ENGINEER DAVID KNOWLTON, P.E.

THE MASSACHUSETTS HIGHWAY DEPARTMENT STANDARD SPECIFICATIONS FOR HIGHWAYS AND BRIDGES DATED 1988, THE MASSDOT MASSACHUSETTS DEPARTMENT OF TRANSPORTATION HIGHWAY DIVISION SUPPLEMENTAL SPECIFICATIONS DATED JULY 1, 2015 AND THE MASSDOT MASSACHUSETTS DEPARTMENT OF TRANSPORTATION HIGHWAY DIVISION INTERIM SUPPLEMENTAL SPECIFICATIONS DATED DECEMBER 31, 2017; THE OCTOBER 2017 CONSTRUCTION STANDARD DETAILS, THE 1990 STANDARD DRAWINGS FOR SIGNS AND SUPPORTS; THE 2009 MANUAL ON UNIFORM TRAFFIC CONTROL DEVICES (MUTCD) WITH THE MASSACHUSETTS AMENDMENTS AND THE STANDARD MUNICIPAL TRAFFIC CODE; THE 1968 STANDARD DRAWINGS FOR TRAFFIC SIGNALS AND HIGHWAY LIGHTING; THE LATEST EDITION OF AMERICAN STANDARD FOR NURSERY STOCK, WILL GOVERN.

FEBRUARY 2018



CITY MAYOR KIMBERLEY DRISCOLL

LEGEND AND ABBREVIATIONS

EXIS	<u>TING</u>	PROPOSED:	
	- · · · · · · · · · · · · · · · · · · ·	田田田田田田田田田田田田田田田田田田田田田田田田田田田田田田田田田田田田	BASELINE CURB CITY APPROX. LAYOUT LINE SAWCUT CATCH BASIN DRAIN MANHOLE CHANGE IN TYPE (CB TO DMH) HYDRANT RAISED INTERSECTION PAVERS FLUSH GRANITE CURB ASPHALT PAVEMENT BREAKLINE DETECTABLE WARNING PANEL SIGN POST COMPOST FILTER TUBE ABANDON ADJUST BY OTHERS ANGLE POINT APPROXIMATE BITUMINOUS BASELINE CEMENT CENTERLINE CONCRETE CONSTRUCTION CROSSWALK DIAMETER EXISTING GALVANIZED HOT MIX ASPHALT HYDRANT LIGHT POLE LEFT MAXIMUM MINIMUM NOT TO SCALE POINT OF CURVATURE POINT OF COMPOUND CURVATURE POINT OF INTERSECTION POINT OF REVERSE CURVATURE POINT OF REVERSE CURVATURE PROPOSED POUNDS PER SQUARE INCH POINT OF TANGENCY REMOVE AND RESET BY OTHERS REMOVE AND RESET BY OTHERS REMOVE AND STACK RIGHT STOP LINE - 12" WIDTH STATION TYPICAL WHEELCHAIR RAMP WHITE TRANSVERSE LINE - 4' SPACE, 3:1 SLOPE - 4" WIDTH

PAVEMENT MARKINGS SYMBOLS

PROPOSED	DESCRIPTION
YIELD	LEGEND "YIELD" - WHITE
cw	CROSSWALK - 12" WIDTH, 2' SPACE
SWL	SOLID WHITE LINE - 6" WIDTH (OR AS INDICATED ON PLAN)
SYL	SOLID YELLOW LINE - 6" WIDTH
WDWLEx	DOTTED WHITE LINE EXTENSION - 12" WIDTH (OR AS INDICATED ON PLAN) - 2' LINE 6' GAP
DBYL	DOUBLE YELLOW LINE - 6" WIDTH
/ / / / /	YELLOW TRANSVERSE LINE - 12" WIDTH - 45° @ 10' O.C.
***	YIELD LINE

GENERAL NOTES:

- 1. PLANS PREPARED ARE BASED ON SURVEY PROVIDED BY MERIDIAN ASSOCIATES. THE LOCATION AND SIZE OF EXISTING PIPES, DUCTS, CONDUITS AND OTHER UNDERGROUND STRUCTURES SHOWN ON THE DRAWINGS ARE NOT WARRANTED TO BE EXACT NOR IS IT WARRANTED THAT ALL UNDERGROUND STRUCTURES, UTILITIES AND SERVICE CONNECTIONS ARE SHOWN. CONTRACTOR SHALL NOTIFY UTILITY COMPANIES IN WRITING AND BY CALLING DIG SAFE (1-888-344-7233) BEFORE EXCAVATION. CONTRACTOR SHALL BEAR FULL RESPONSIBILITY FOR LOCATING ALL EXISTING UTILITIES PRIOR TO EXCAVATION THROUGHOUT THE ENTIRE CONSTRUCTION DURATION.
- 2. PROPERTY LINE INFORMATION IS COMPILED FROM FIELD OBSERVATIONS, CITY LAYOUT PLANS, CITY ASSESSORS PLANS, AND PLANS RECORDED AT THE ESSEX COUNTY REGISTRY OF DEEDS.
- 3. THE BEARING SYSTEM FOR THE PLANS IS BASED UPON MASSACHUSETTS STATE PLANE
- 4. VERTICAL DATUM: SALEM CITY BASE DATUM
- . HORIZONTAL DATUM: NORTH AMERICAN DATUM OF 1983 (NAD83)
- 6. ALL BASELINE TIES FOR CORNERS AND RADII OF CURB OR EDGING ARE TO THE P.C.'S OR P.T.'S. UNLESS OTHERWISE NOTED.
- 7. ALL EXISTING SIGNS SHALL BE REMOVED AND REPLACED IN KIND WITH NEW SIGNS AND CHANNEL POSTS UNLESS OTHERWISE NOTED. MAILBOXES SHALL BE REMOVED AND RESET UNLESS OTHERWISE NOTED.
- 8. ALL TRAFFIC SIGNAL HARDWARE (INCLUDING MAST ARMS, PULL BOXES, PEDESTALS & CONTROLLER BOXES), PARKING METERS, LIGHT/UTILITY POLES, FENCES, STONE BOUNDS, GRANITE BOUNDS, AND OTHER PROPERTY MARKERS ARE TO BE RETAINED AND PROTECTED UNLESS OTHERWISE NOTED ON PLANS. PULLBOXES ARE TO BE RETAINED AND ADJUSTED TO GRADE.
- 9. THE CONTRACTOR SHALL SAWCUT TO THE FULL PAVEMENT DEPTH AT LOCATIONS WHERE NEW FULL DEPTH PAVEMENT OR NEW SIDEWALK MEETS EXISTING PAVEMENT OR SIDEWALK, AT THE LOCATIONS SHOWN ON THE PLANS AND AS REQUIRED BY THE ENGINEER. PROPOSED WORK SHALL MATCH EXISTING LINE AND GRADE AT LIMITS OF WORK
- 10. ALL AREAS OUTSIDE OF THE LIMIT OF WORK DISTURBED BY THE CONTRACTOR'S OPERATIONS SHALL BE RESTORED TO THEIR ORIGINAL CONDITION BY THE CONTRACTOR AT NO ADDITIONAL COST TO THE OWNER.
- 11. EXISTING TREES WITHIN THE LIMIT OF WORK SHALL BE RETAINED AND PROTECTED UNLESS OTHERWISE NOTED OR REQUIRED BY ENGINEER. IN THE EVENT THAT A PROPOSED CATCH BASIN IS WITHIN 6' OF AN EXISTING TREE, THE INFORMATION SHALL BE FURNISHED TO THE ENGINEER FOR RESOLUTION PRIOR TO INSTALLATION OF THE CATCH BASIN.
- 12. MATCH GRADE AT WALKS, BACK OF WALKS AND DRIVES UNLESS OTHERWISE DIRECTED BY THE ENGINEER OR AS INDICATED ON THE PLANS. IF GRADE AT BACK OF WALK CANNOT BE MET, CONTRACTOR SHALL UTILIZE APPROPRIATE TREATMENT SUCH AS CURB AT BACK OF WALK, FEATHERING OF LOAM, ETC. TO BEST MATCH GRADE AT BACK OF WALK TO THE SATISFACTION OF THE ENGINEER.
- 13. ALL GRANITE CURB, EDGING, AND CURB CORNERS THAT ARE NOT SUITABLE FOR REUSE AS DETERMINED BY THE ENGINEER SHALL BE REMOVED AND DISCARDED BY THE CONTRACTOR AT NO ADDITIONAL COST. GRANITE CURB OR EDGING TO BE RESET SHALL NOT BE RANDOMLY MIXED WITH NEW CURB, BUT SHALL BE RESET SO AS TO GIVE A UNIFORM APPEARANCE.
- 14. ALL PROPOSED GRANITE CURB SHALL BE TYPE VA 4, UNLESS OTHERWISE NOTED.
- 15. ALL FLUSH CURB ENCOUNTERED AT DRIVEWAYS SHALL BE REMOVED AND RE-USED ELSEWHERE OR DISPOSED AS DIRECTED BY ENGINEER, UNLESS OTHERWISE NOTED.
- 16. ALL PROPOSED WHEELCHAIR RAMPS ARE TO CONFORM TO THE LATEST AAB AND ADA WHEELCHAIR RAMP STANDARDS. IF THERE IS A CONFLICT, THE INFORMATION SHALL BE FURNISHED TO THE ENGINEER FOR RESOLUTION PRIOR TO SIDEWALK RECONSTRUCTION. TACTILE WARNING PADS FOR PROPOSED WHEELCHAIR RAMPS SHALL BE BRICK RED COLOR.
- 17. ALL EXISTING CURB STOPS, VALVE BOXES, CASTINGS AND HYDRANTS, IN AREAS TO BE REPAVED SHALL BE PROTECTED AND ADJUSTED TO LINE AND GRADE BY THE CONTRACTOR, UNLESS OTHERWISE DIRECTED BY ENGINEER.
- 18. THE CONTRACTOR SHALL VERIFY ALL OUTLET GRADES OF DRAINAGE STRUCTURES PRIOR TO CONSTRUCTING ANY DRAINAGE MODIFICATIONS. CONTRACTOR TO CONFIRM LOCATION OF EXISTING UTILITIES WITH TEST PITS.
- 19. WHERE AN EXISTING UTILITY IS FOUND TO CONFLICT WITH THE PROPOSED WORK, THE LOCATION, ELEVATION AND SIZE OF THE UTILITY SHALL BE ACCURATELY DETERMINED WITHOUT DELAY BY THE CONTRACTOR, AND THE INFORMATION FURNISHED TO THE ENGINEER FOR RESOLUTION OF THE CONFLICT.
- 20. THE CONTRACTOR SHALL ADJUST ALL UTILITY FRAMES AND COVERS AS REQUIRED. CONTRACTOR TO ARRANGE FOR INSPECTION OF ALL WORK ON UTILITIES WITH THE APPROPRIATE UTILITY COMPANY. IN THE EVENT ANY UTILITY COMPANY DOES NOT ALLOW THE CONTRACTOR TO MAKE THE ADJUSTMENTS, THE CONTRACTOR SHALL COORDINATE HIS WORK TO ALLOW FOR THE ADJUSTMENTS TO BE MADE BY THE UTILITY OR ITS DESIGNEE. THE EXPECTED UTILITIES INCLUDE BUT ARE NOT LIMITED TO: WATER, GAS & ELECTRIC. TELEPHONE & CATV AND FIRE.

- 21. CONTRACTOR SHALL OBTAIN ALL NECESSARY PERMITS AND APPROVALS REQUIRED TO PERFORM THE WORK, INCLUDING ALL PERMITS REQUIRED BY THE CITY OF SALEM DEPARTMENT OF PUBLIC WORKS AND/OR WATER DEPARTMENT.
- 22. PRIOR TO THE START OF CONSTRUCTION, CONTRACTOR SHALL COORDINATE ANY UTILITY RELOCATIONS WITH THE CITY OF SALEM DEPARTMENT OF PUBLIC WORKS AND ALL RESPECTIVE UTILITY AGENCIES. LOCATIONS FOR RELOCATED UTILITIES ARE TO BE DETERMINED BY THE RESPECTIVE UTILITY AGENCY IN CONSULTATION WITH THE SALEM DEPARTMENT OF PUBLIC WORKS.
- 23. CONTRACTOR SHALL FOLLOW CITY OF SALEM DEPARTMENT OF PUBLIC WORKS STANDARD DETAILS WHERE APPLICABLE. ALL WORK DONE UNDER THIS CONTRACT SHALL BE COMPLETED IN CONFORMANCE TO MASSDOT "STANDARD SPECIFICATIONS FOR HIGHWAYS & BRIDGES" AND ANY UPDATES OR SUPPLEMENTAL SPECIFICATIONS PERTAINING THERETO, AND SPECIFICATIONS INCLUDED IN THIS CONTRACT.
- 24. WORK SHALL NOT EXTEND BEYOND EXISTING ROW UNLESS OTHERWISE NOTED ON PLANS OR AS REQUIRED BY ENGINEER.
- 25. INLETS AND OUTLETS FROM DRAINAGE STRUCTURES REMOVED SHALL BE PLUGGED WITH BRICK MASONRY NOT LESS THAN 8" IN THICKNESS, CONSISTENT WITH MASSDOT STANDARD SPECIFICATIONS FOR HIGHWAYS AND BRIDGES SECTION 201. PIPES LARGER THAN 24" SHALL BE BACKFILLED WITH FLOWABLE FILL TO THE SATISFACTION
- 26. NO WORK SHALL TAKE PLACE ON PRIVATE PROPERTY WITHOUT A SIGNED RIGHT OF ENTRY AGREEMENT BETWEEN THE PROPERTY OWNER AND THE CITY.
- 27. IN TREE LOCATIONS WHERE TREE ROOTS ARE DAMAGING EXISTING CURB, THE CONTRACTOR MUST COORDINATE THE CURB REMOVAL WITH THE CITY ARBORIST PRIOR TO REMOVING CURB.
- 28. WHEN FITTING GRANITE CURB OVER EXISTING UTILITIES AND OTHER OBSTRUCTIONS, NOTCHING AND CUTTING OF CURB SHALL TAKE PLACE WITH NO ADDITIONAL COST TO CITY OF SALEM.
- 29. CONTRACTOR SHALL PROVIDE A STAKED LAYOUT FOR THE ENGINEER TO REVIEW PRIOR TO COMMENCING SIDEWALK WORK. THE CONTRACTOR SHALL PROVIDE ALL CUT AND FILL AMOUNTS AT ALL BACK OF SIDEWALK, STEPS, WALLS, DRIVEWAYS, WALKWAYS, BUILDING ENTRANCES, UTILITY STRUCTURES, ETC. ALL DISCREPANCIES THAT WILL CAUSE THE SIDEWALK NOT TO BE COMPLIANT WILL BE BROUGHT TO THE ENGINEER'S ATTENTION.
- 30. FOR ALL PAY REQUESTS, CONTRACTOR SHALL PROVIDE BACK UP STATING DATES INSTALLED, QUANTITY INSTALLED, CALCULATION ON QUANTITY, AND A MARKED UP DRAWING SHOWING LOCATION INSTALLED.
- 31. ALL EXISTING "D" GRATES FOR CATCH BASINS SHALL BE REPLACED WITH CITY STANDARD FRAME AND GRATE.
- 32. ALL PAVEMENT MARKINGS SYMBOLS SHALL BE THERMOPLASTIC.
- 33. THE CONTRACTOR SHALL BE RESPONSIBLE FOR ALL STAGING AND STOCKPILING AREAS AT NO ADDITIONAL COST TO THE CITY. NO STAGING OR STOCKPILING AREAS SHALL BE ALLOWED WITHIN THE CITY ROW UNLESS APPROVED IN ADVANCE BY THE CITY ENGINEER.
- 34. THE CONTRACTOR SHALL MAINTAIN PEDESTRIAN ACCESS THROUGH THE PROJECT SITE AT ALL TIMES. ALL LABOR, MATERIALS, TOOLS AND EQUIPMENT REQUIRED TO MAINTAIN PEDESTRIAN ACCESS SHALL BE INCLUDED IN THE COST FOR ITEM 657.1 PEDESTRIAN GUIDANCE SYSTEM AT WORK ZONES.
- 35. THE CONTRACTOR SHALL BE REQUIRED TO NOTIFY ALL PROJECT ABUTTERS VIA DOOR HANGERS ONE (1) WEEK PRIOR TO COMMENCING WORK AT THE PROJECT SITE AND ONE (1) WEEK PRIOR TO CHANGING TRAFFIC PATTERNS AT THE PROJECT SITE.
- 36. THE CONTRACTOR SHALL BE REQUIRED TO COORDINATE ALL PROJECT RELATED CONSTRUCTION ACTIVITIES WITH THE REMOVAL OR RELOCATION OF EXISTING UTILITY POLES/OVERHEAD WIRES AND THE INSTALLATION OF NEW UTILITY POLES/OVERHEAD WIRES, AS NOTED ON THE CONTRACT DRAWINGS, BY NATIONAL GRID ELECTRIC. PLEASE REFER TO THE SPECIAL PROVISIONS FOR MORE DETAILED INFORMATION.



Stantec Consulting Services Inc. 5 Burlington Woods Drive, Suite 300 Burlington MA 01803 U.S.A. Tel. 781.221.1000

Copyright Reserved

www.stantec.com

The Contractor shall verify and be responsible for all dimensions. DO NOT scale the drawing - any errors or omissions shall be reported to Stantec without delay.

The Copyrights to all designs and drawings are the property of Stantec. Reproduction or use for any purpose other than that authorized by Stantec is forbidden.

Consultants

Legend

Notes

Revision

By Appd. YY.MM.DD

Issued

By Appd. YY.MM.DD

File Name: leg_abbr_notes.dwg

SEA RAA SEA 17.09.06



Permit-Seal

Client/Project
City of Salem, MA

Swampscott Road at First Street Roundabout Construction Salem, MA

_____ Title LEGEND, ABBREVIATIONS

& GENERAL NOTES

Project No. Scale
179410490 NOT TO SCALE


Drawing No.

Sheet

2 of 37


Revision

ORIGINAL SHEET - ARCH D

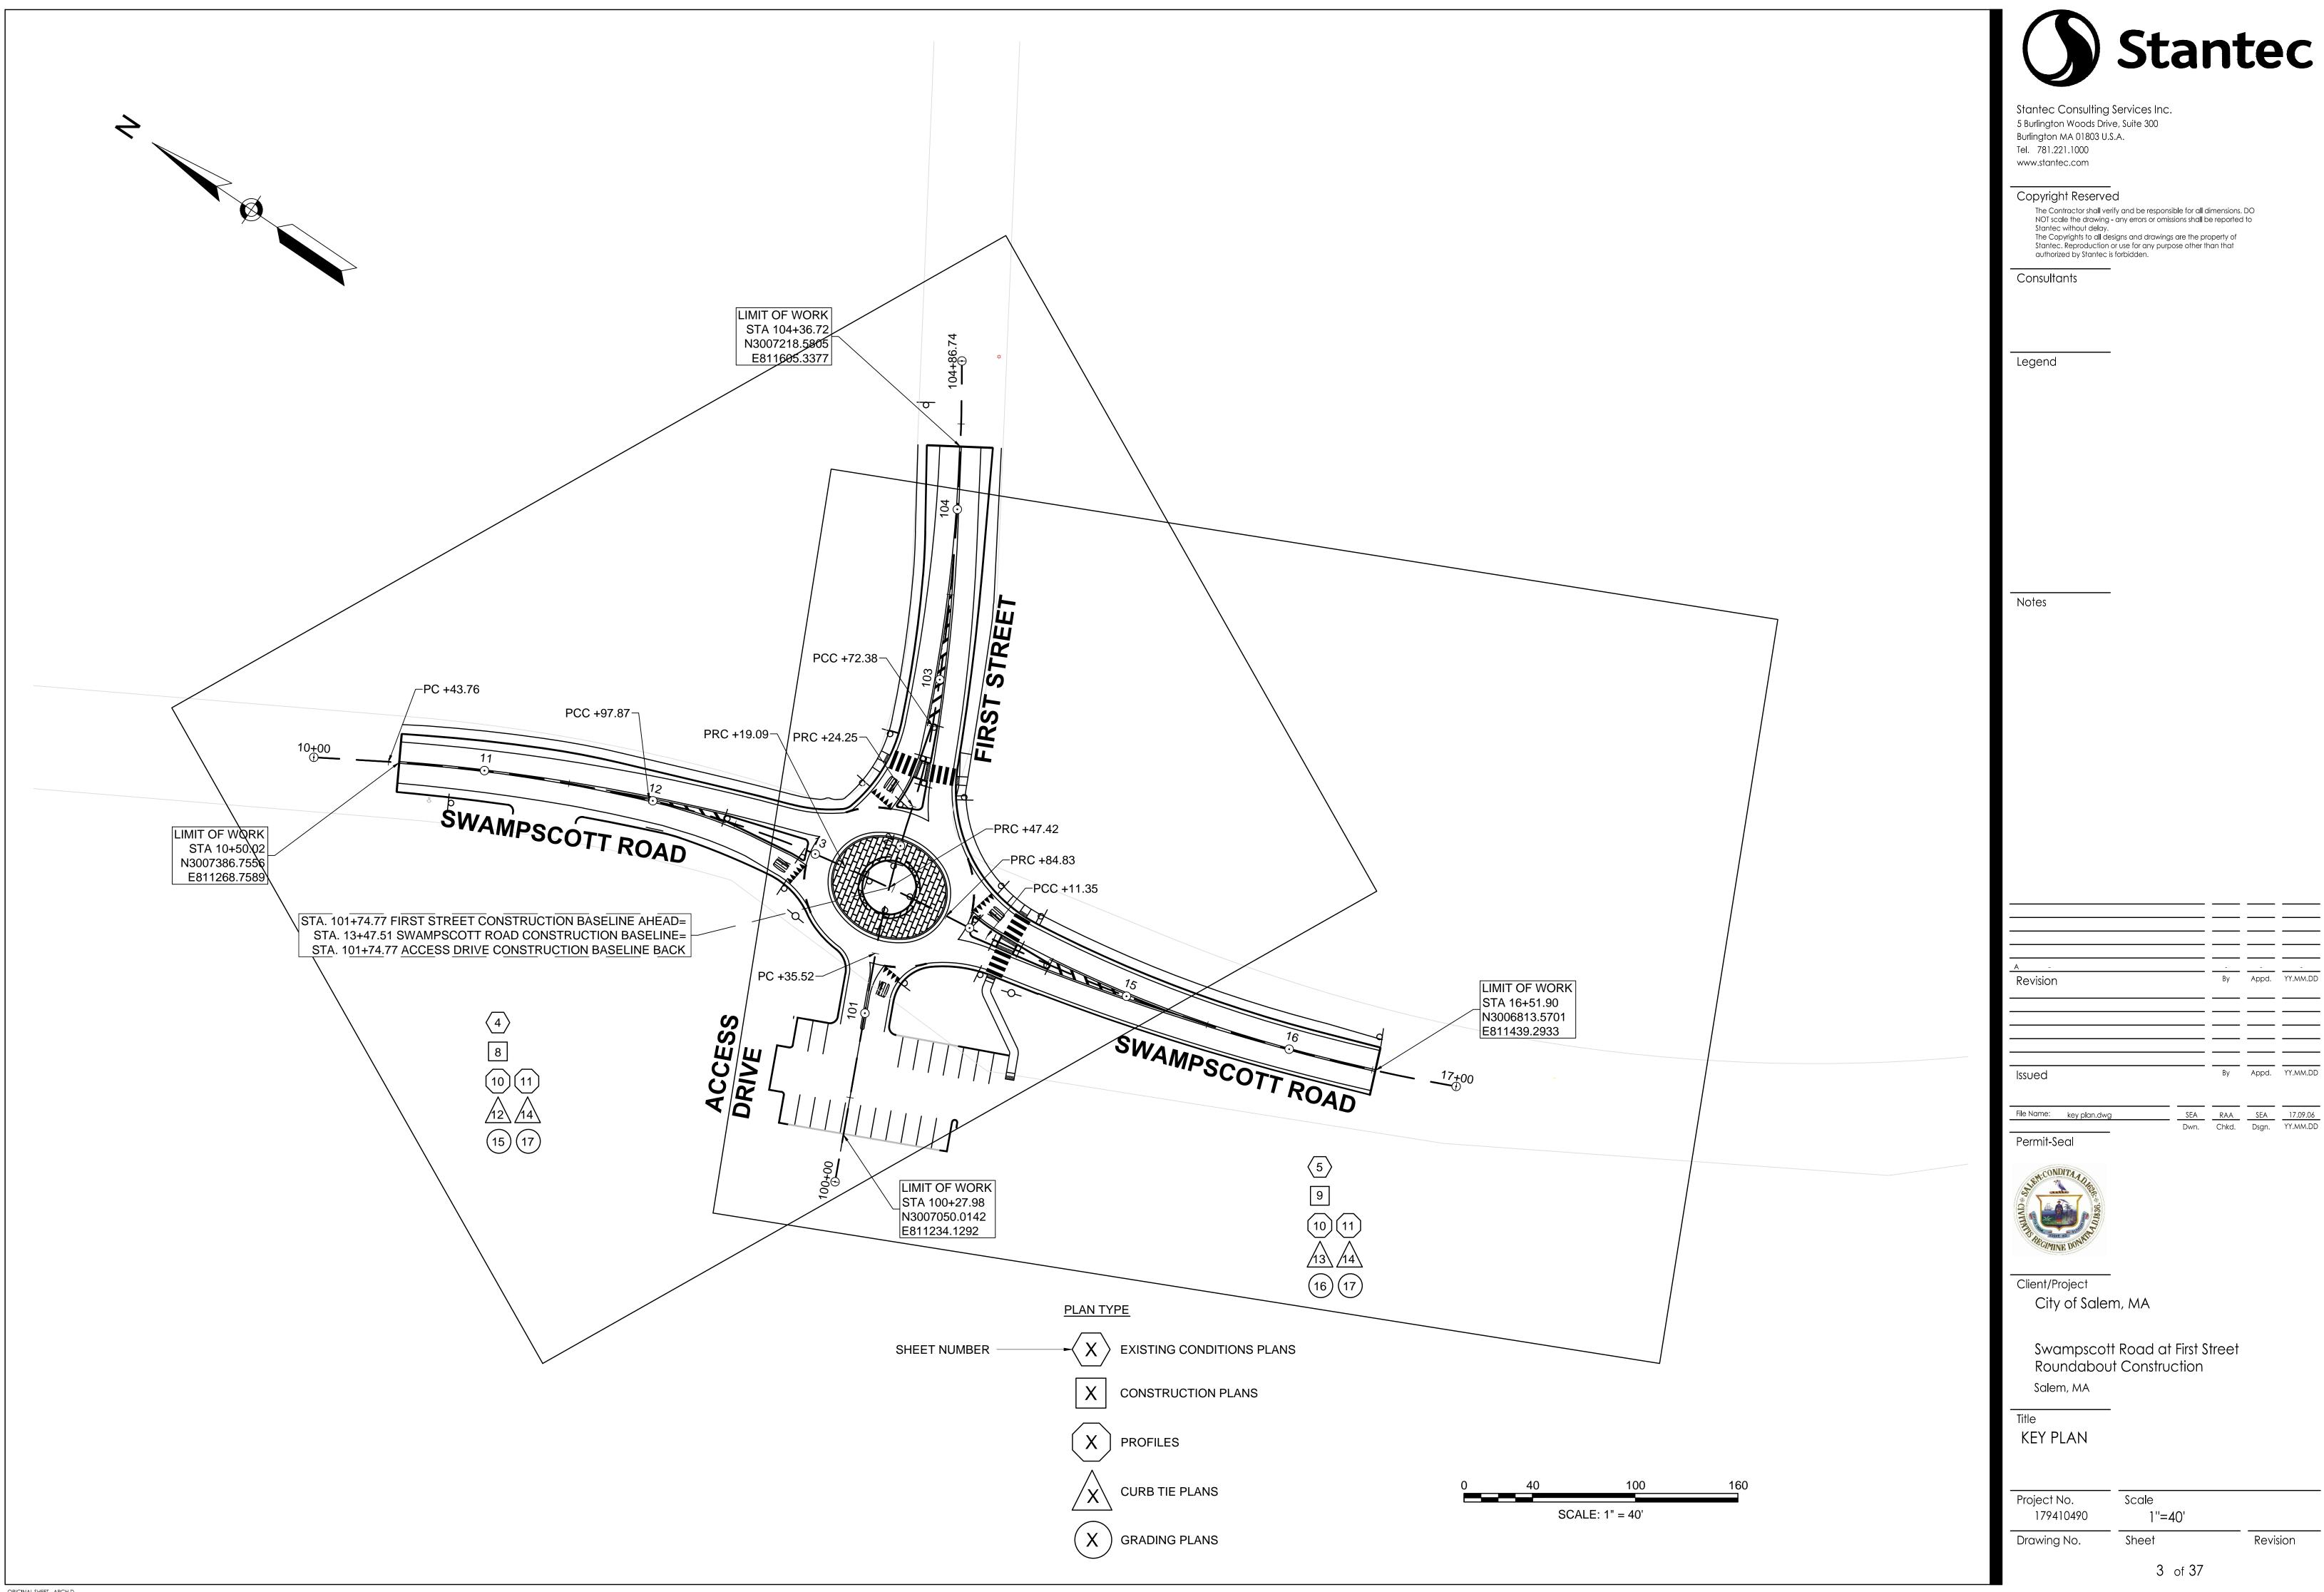




By Appd. YY.MM.DD

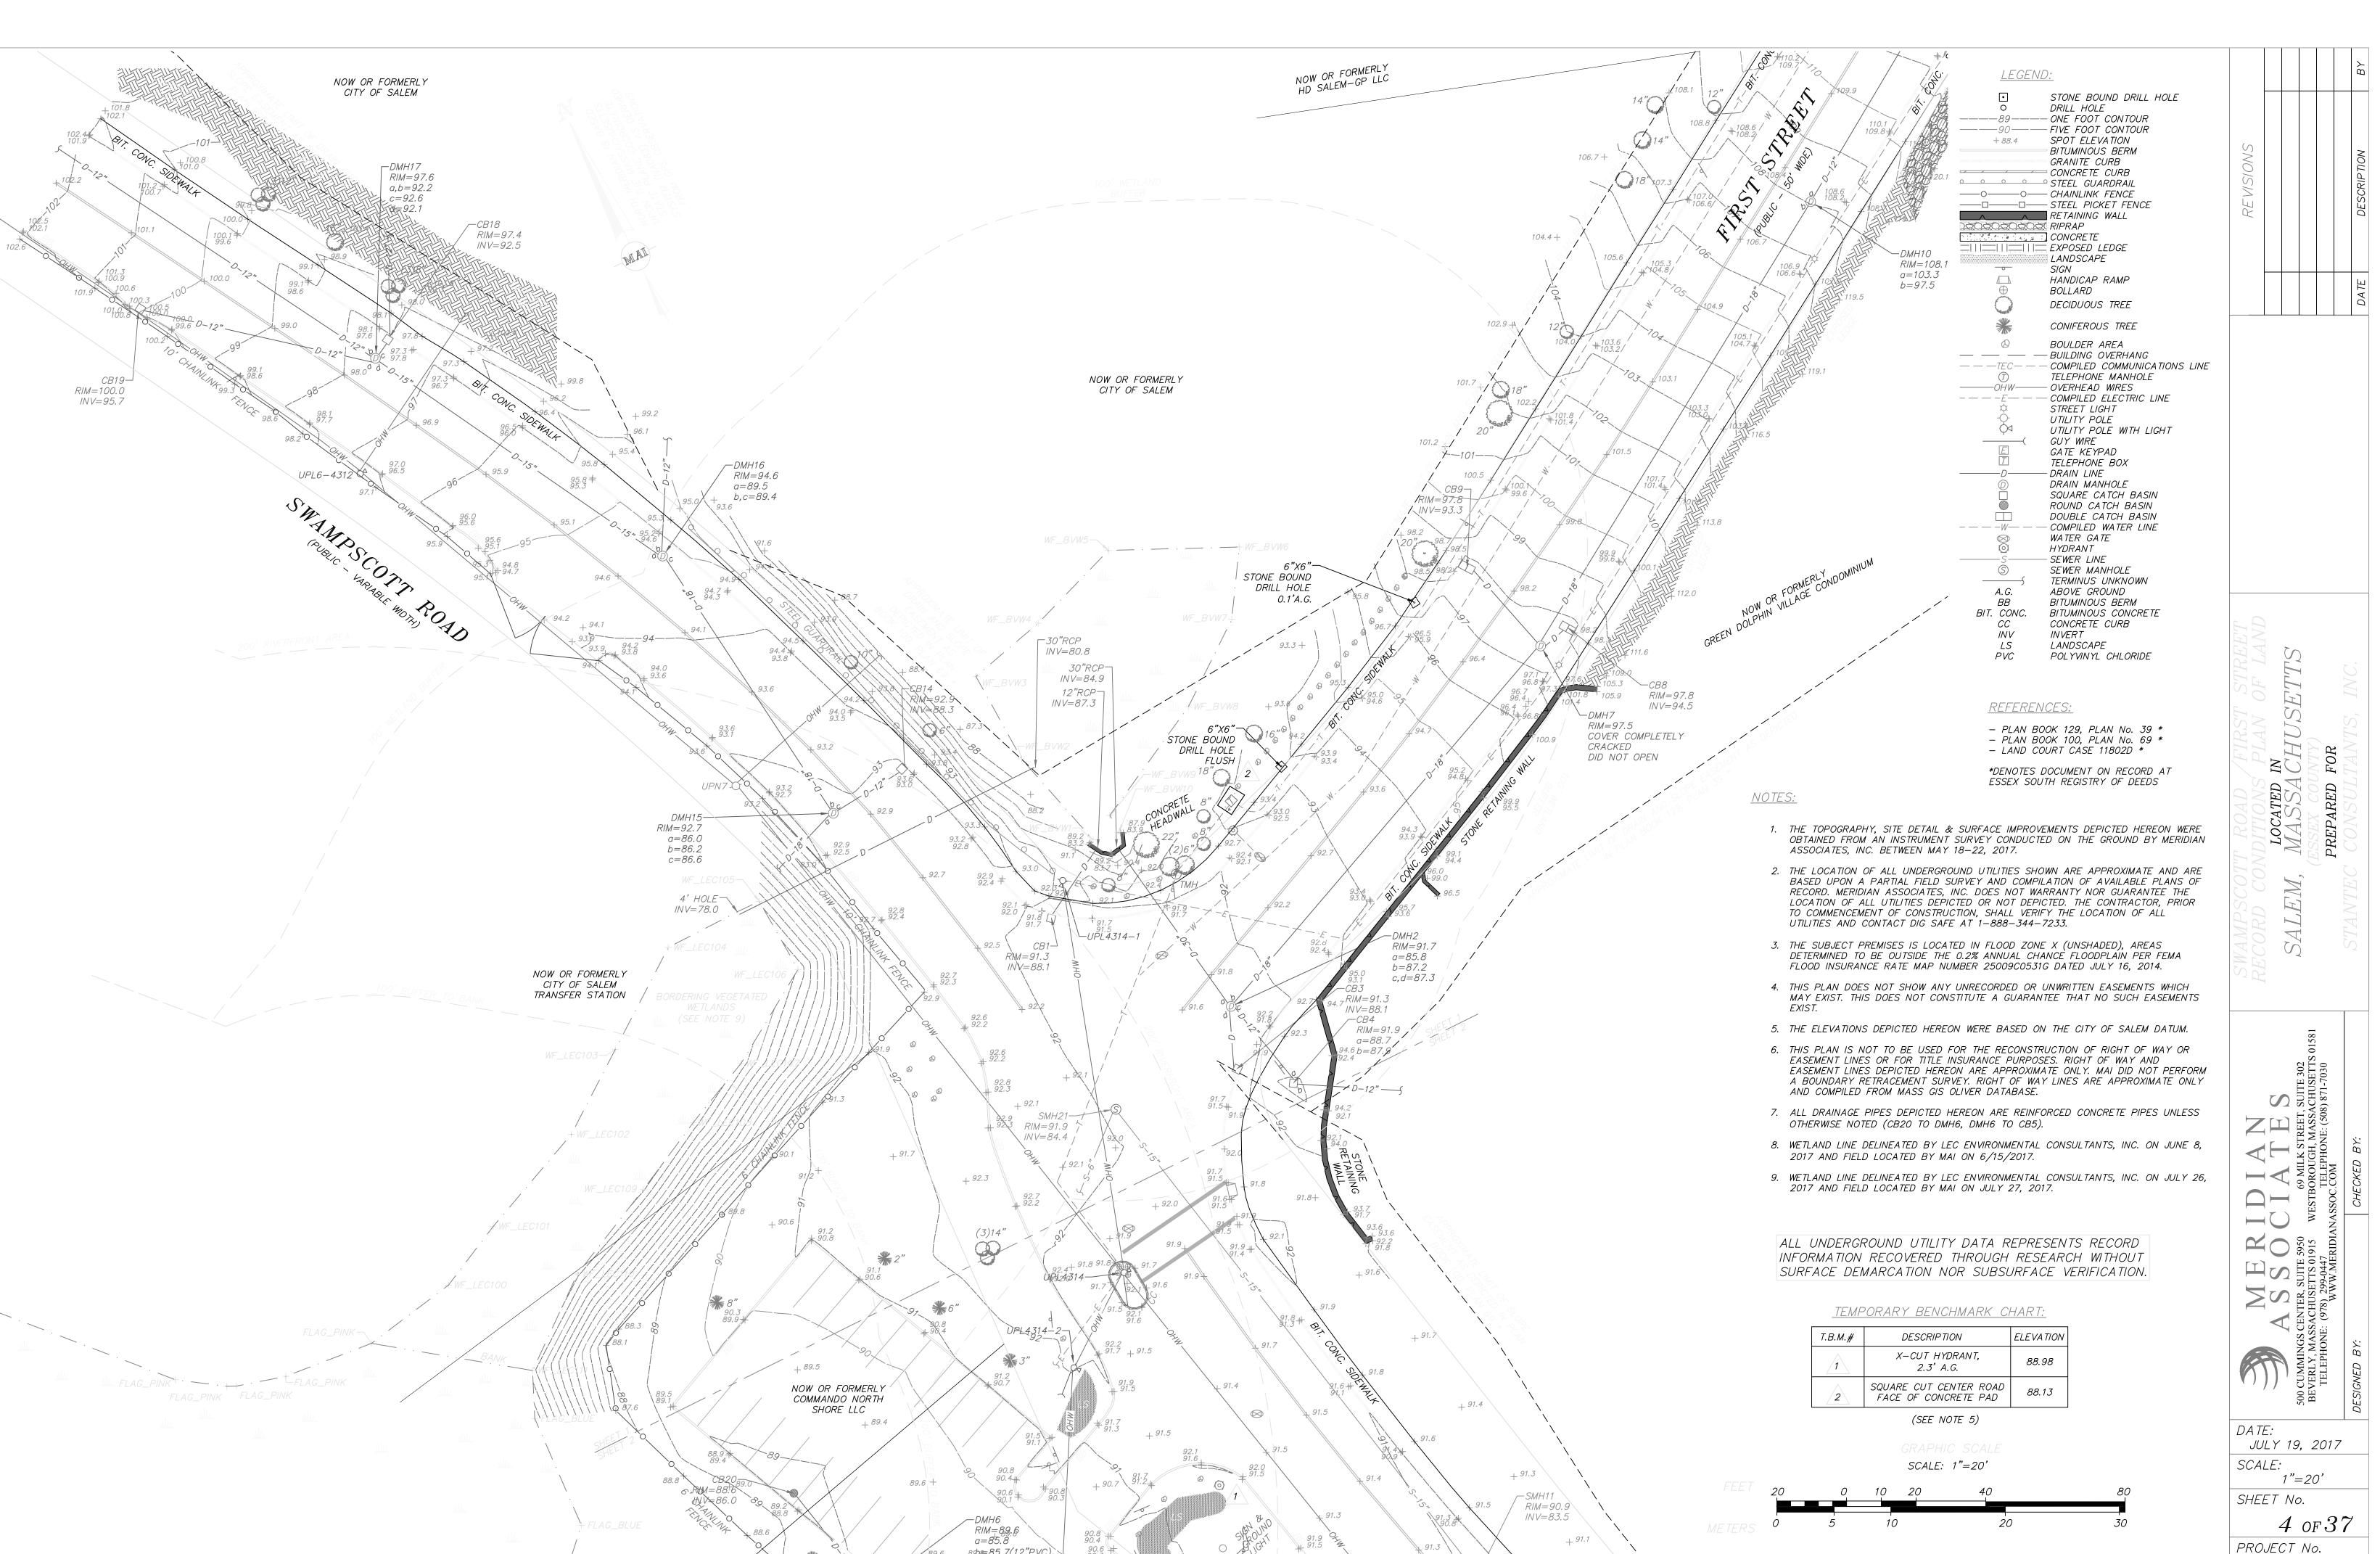


DWG. No. 5986_REC BK. #633, PG. #23 Copyright 🗘 by Meridian Associates, Inc. All rights reserved.

5986

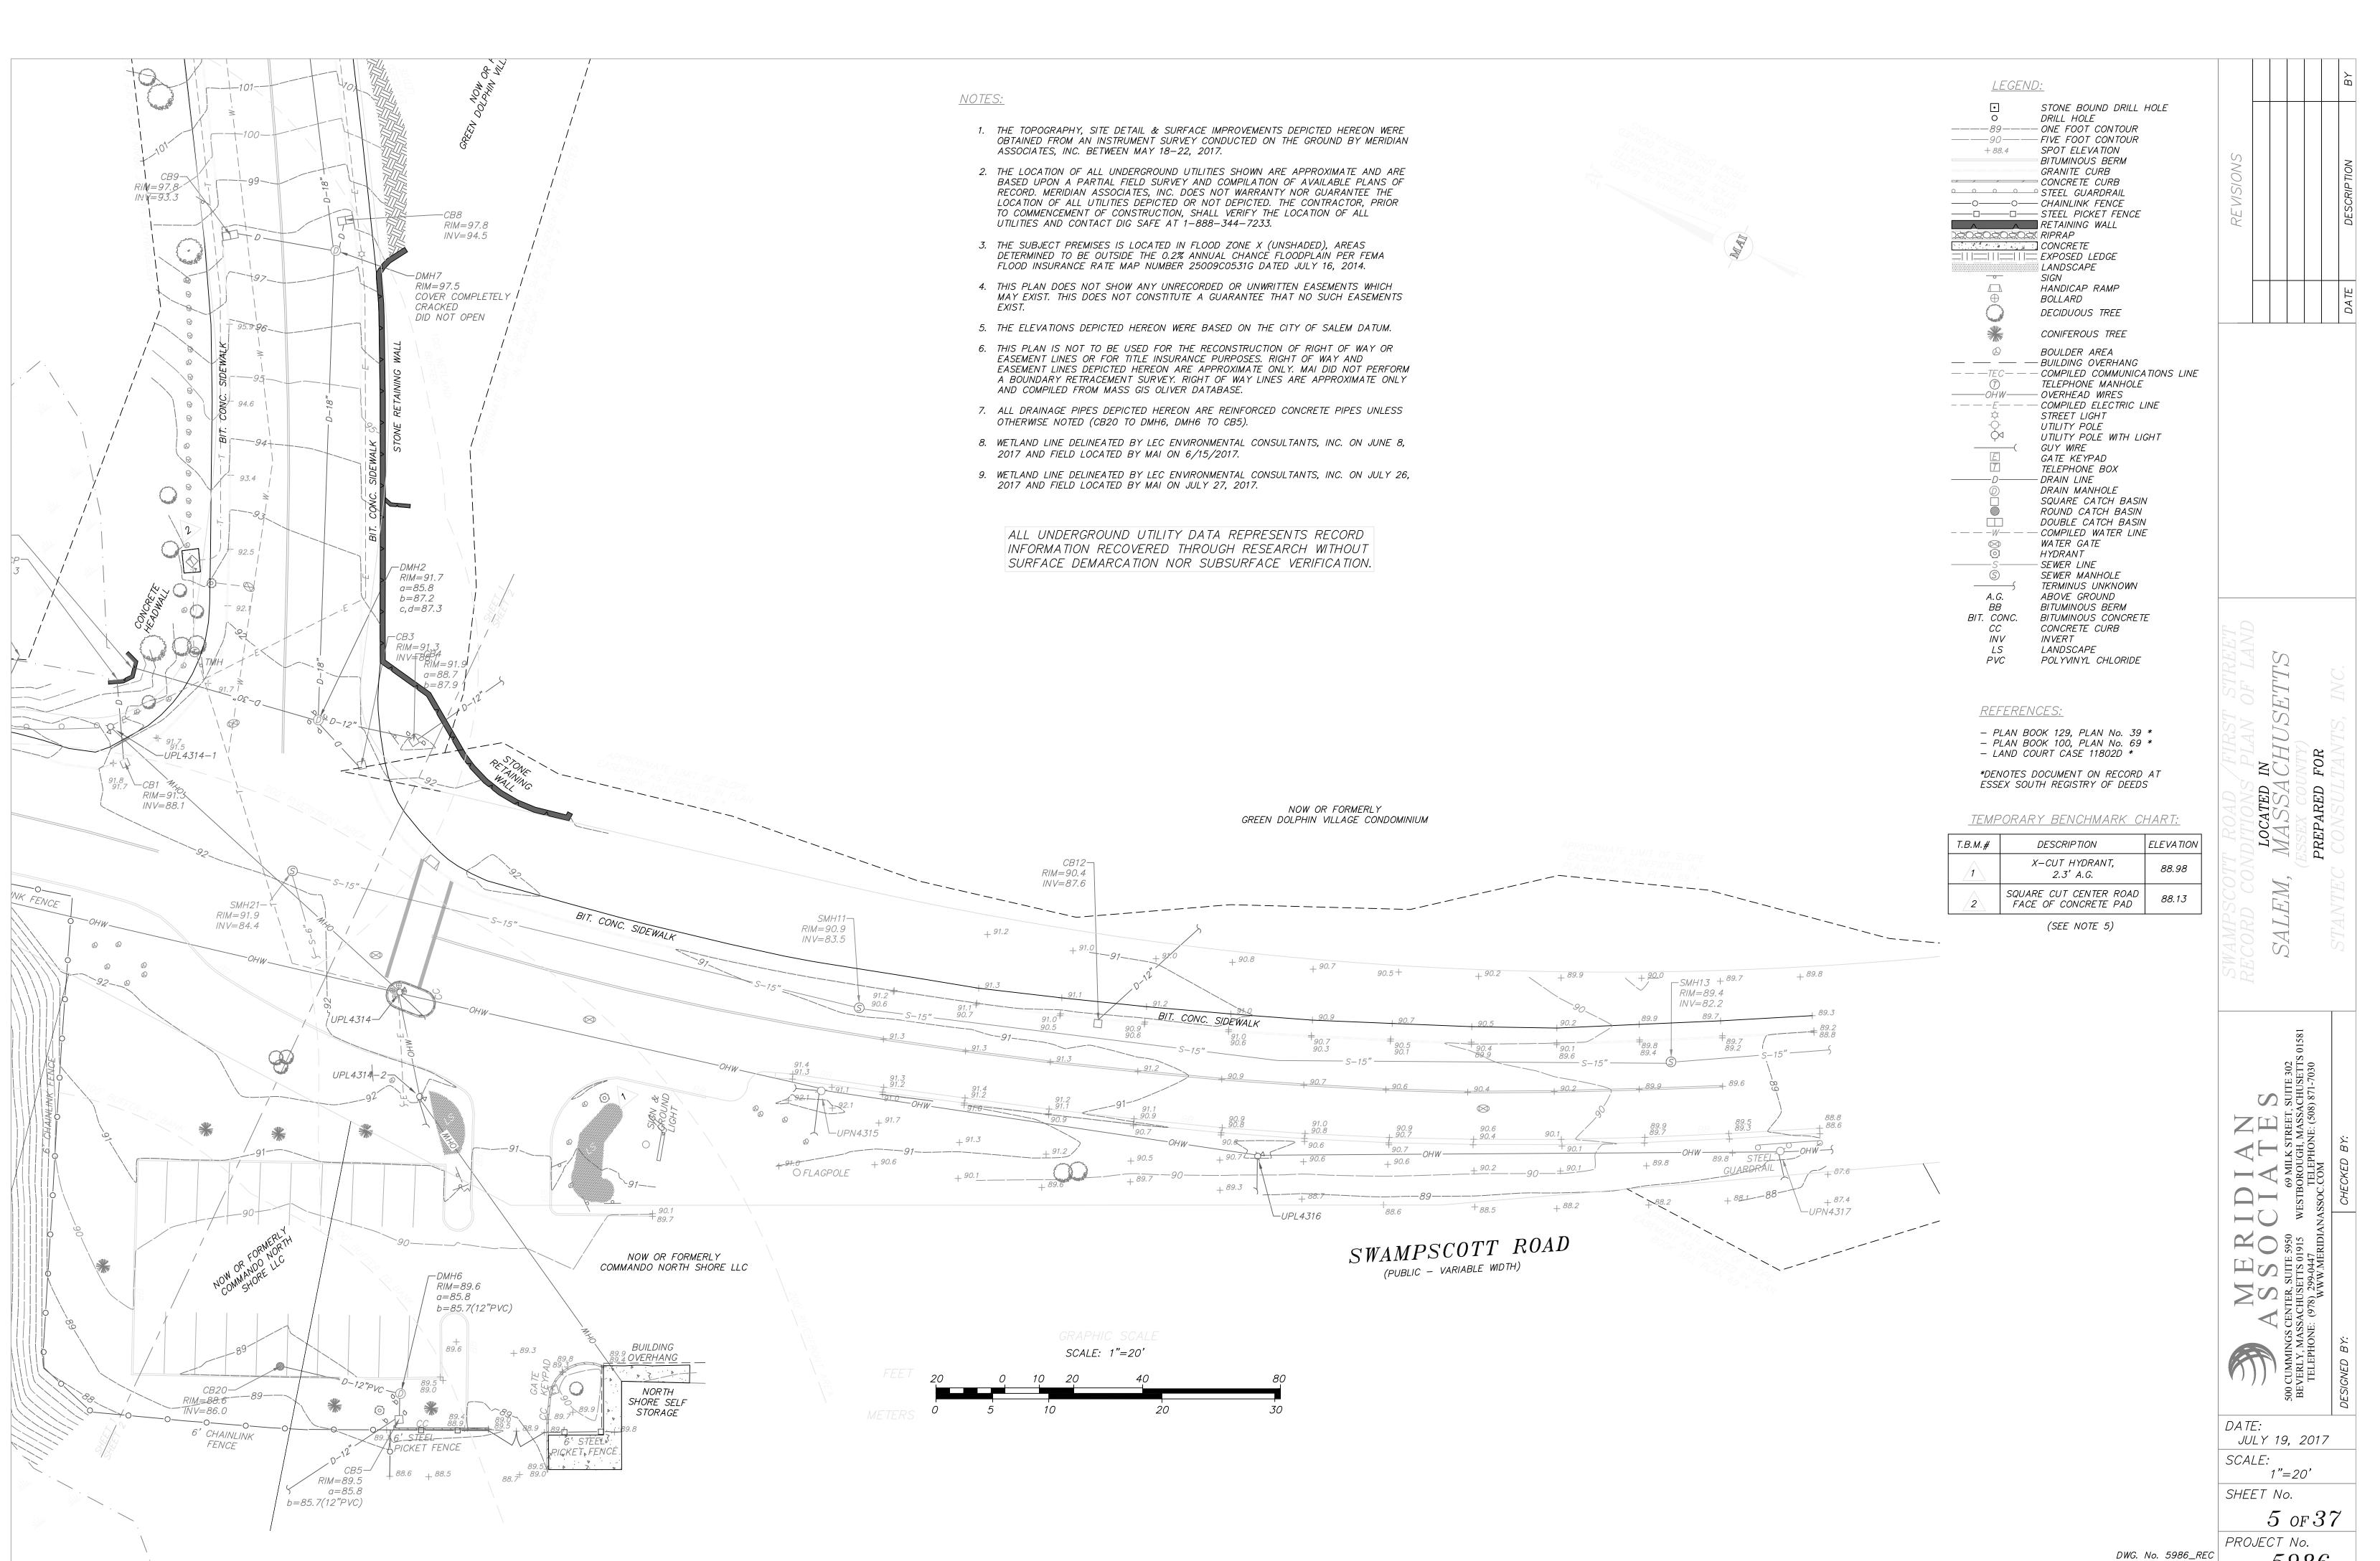

BK. #633, PG. #23

5986 Copyright • by Meridian Associates, Inc. All rights reserved.

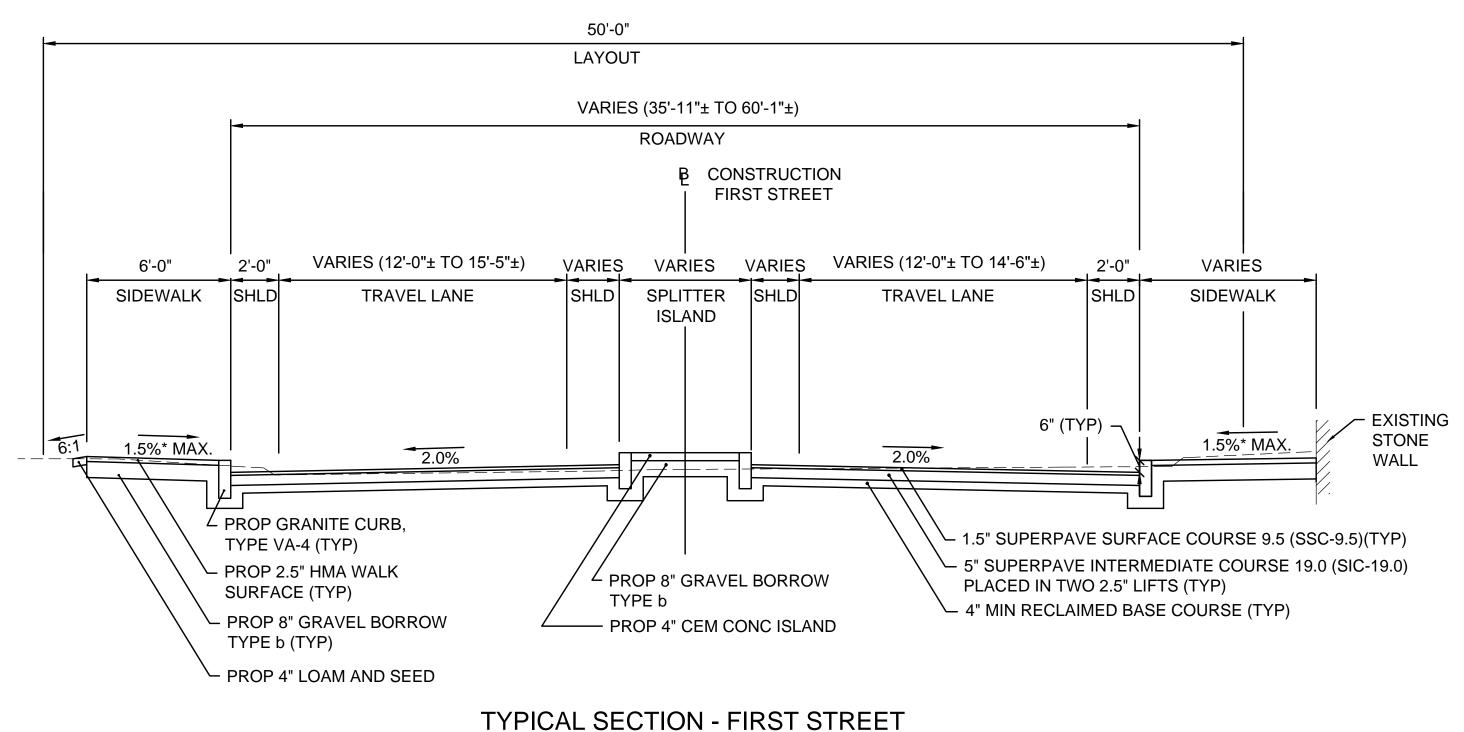

STA. 102+22± TO STA. 102+74±

PAVEMENT NOTES:

PAVEMENT RECLAMATION (SWAMPSCOTT ROAD AND FIRST STREET):

SURFACE: 1.5" SUPERPAVE SURFACE COURSE 9.5 (SSC-9.5) OVER 5" SUPERPAVE INTERMEDIATE COURSE 19.0 (SIC-19.0)

(PLACED IN TWO 2.5" LIFTS)

4" MIN* RECLAIMED BASE COURSE MATERIAL * MAY REQUIRE OVER EXCAVATION OF SUB-BASE MATERIAL TO MEET

MINIMUM DEPTH

RECLAIM: 12" DEPTH

PAVEMENT MILL AND HMA OVERLAY (SWAMPSCOTT ROAD AND FIRST STREET):

SURFACE: 1.5" SUPERPAVE SURFACE COURSE 9.5 (SSC-9.5)

VARIABLE LEVELING COURSE: 0" - 2" SUPERPAVE SURFACE COURSE 9.5 (SSC-9.5)

MILLING: 1.5" MICROMILL

FULL DEPTH PAVEMENT WIDENING IN MILL/OVERLAY AREAS (SWAMPSCOTT ROAD):

SURFACE: 1.5" SUPERPAVE SURFACE COURSE 9.5 (SSC-9.5) OVER 2.5" SUPERPAVE INTERMEDIATE COURSE 19.0 (SIC-19.0)

BASE: 6" HIGH EARLY STRENGTH CEMENT CONCRETE OVER


8" GRAVEL BORROW, TYPE b

FULL DEPTH PAVEMENT WIDENING IN RECLAMATION AREA AND ACCESS DRIVEWAY (SWAMPSCOTT ROAD AND FIRST STREET):


SURFACE: 1.5" SUPERPAVE SURFACE COURSE 9.5 (SSC-9.5) OVER 5" SUPERPAVE INTERMEDIATE COURSE 19.0 (SIC-19.0)

(PLACED IN TWO 2.5" LIFTS)

12" MIN RECLAIMED BASE COURSE MATERIAL

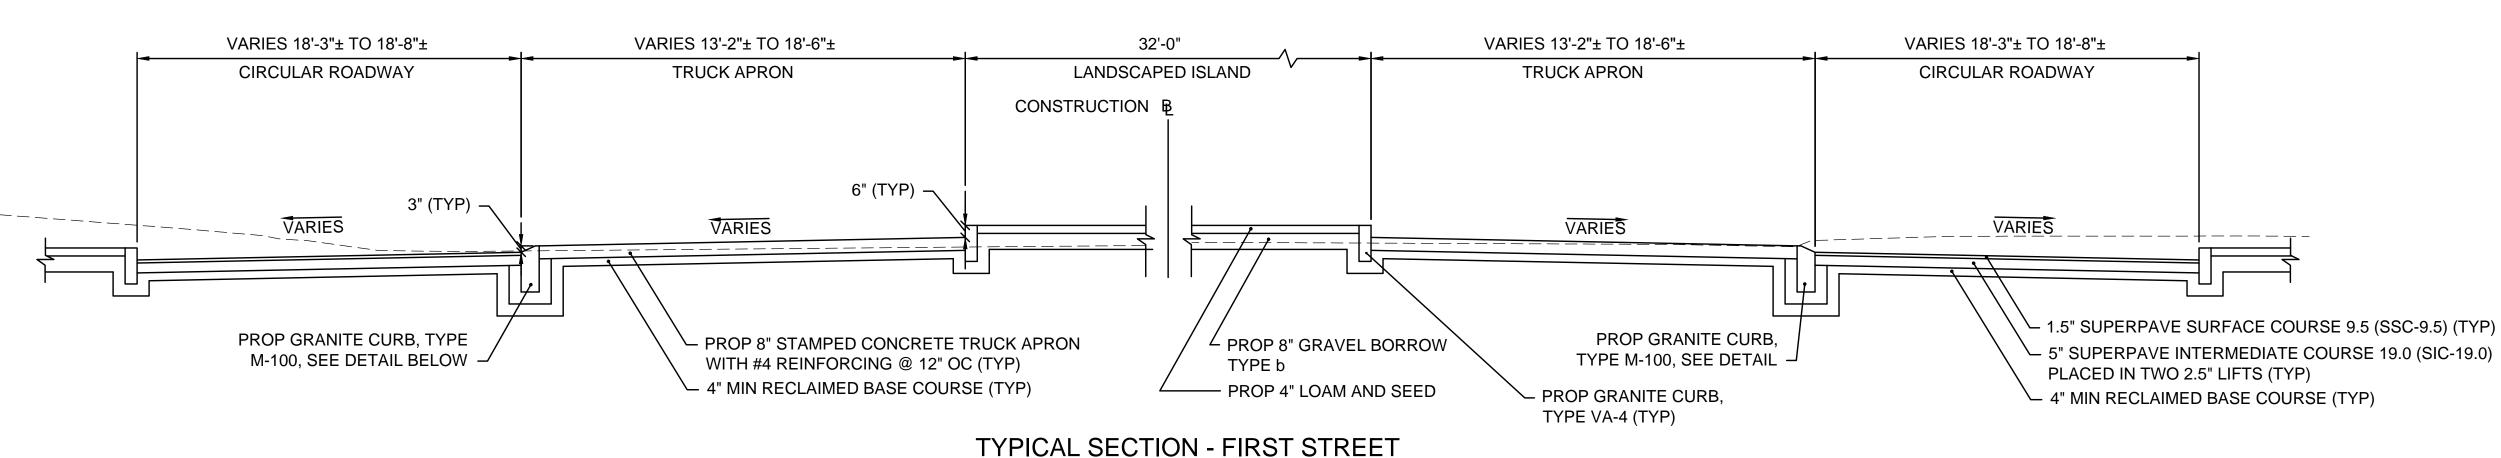

STA. 101+30± TO STA. 102+22± TYPICAL SECTION - SWAMPSCOTT ROAD STA. 12+95± TO STA. 14+00±

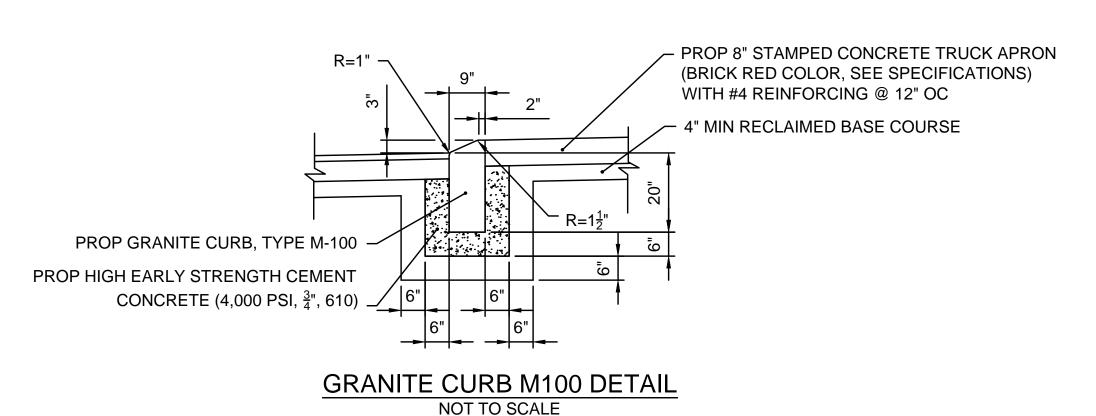

₿ CONSTRUCTION ACCESS DRIVE **VARIES** 2'-0" 13'-0" 13'-0" 2'-0" VARIES TRAVEL LANE TRAVEL LANE SHLD 6" (TYP) -2.0% 2.0% PROP HMA CURB - TYPE 2 (TYP) ► PROP 4" LOAM AND SEED - 1.5" SUPERPAVE SURFACE COURSE 9.5 (SSC-9.5)

30'-0"

ROADWAY

TYPICAL SECTION - ACCESS DRIVE STA. 100+90± TO STA. 101+30±

- 5" SUPERPAVE INTERMEDIATE COURSE 19.0 (SIC-19.0) PLACED IN TWO 2.5" LIFTS 12" MIN RECLAIMED BASE COURSE

HOR. SCALE IN FEET

VER. SCALE IN FEET

Stantec Consulting Services Inc. 5 Burlington Woods Drive, Suite 300 Burlington MA 01803 U.S.A. Tel. 781.221.1000

Copyright Reserved

www.stantec.com

The Contractor shall verify and be responsible for all dimensions. DO NOT scale the drawing - any errors or omissions shall be reported to The Copyrights to all designs and drawings are the property of Stantec. Reproduction or use for any purpose other than that authorized by Stantec is forbidden.

Consultants

Legend

File Name: typical sections.dwg

Permit-Seal



Client/Project City of Salem, MA

Swampscott Road at First Street Roundabout Construction Salem, MA

TYPICAL SECTIONS PART - 1

Scale Project No. 179410490 1''=40' Drawing No. Sheet Revision


6 of 37

ASPHALT EMULSION FOR TACK COAT SHALL BE PLACED ON ALL MILLED SURFACES (APPLICATION RATE = 0.07 GAL/SY) AND BETWEEN ALL NEW PAVEMENT LAYERS

(APPLICATION RATE = 0.05 GAL/SY)

ASPHALT EMULSION FOR TACK COAT:

ORIGINAL SHEET - ARCH D

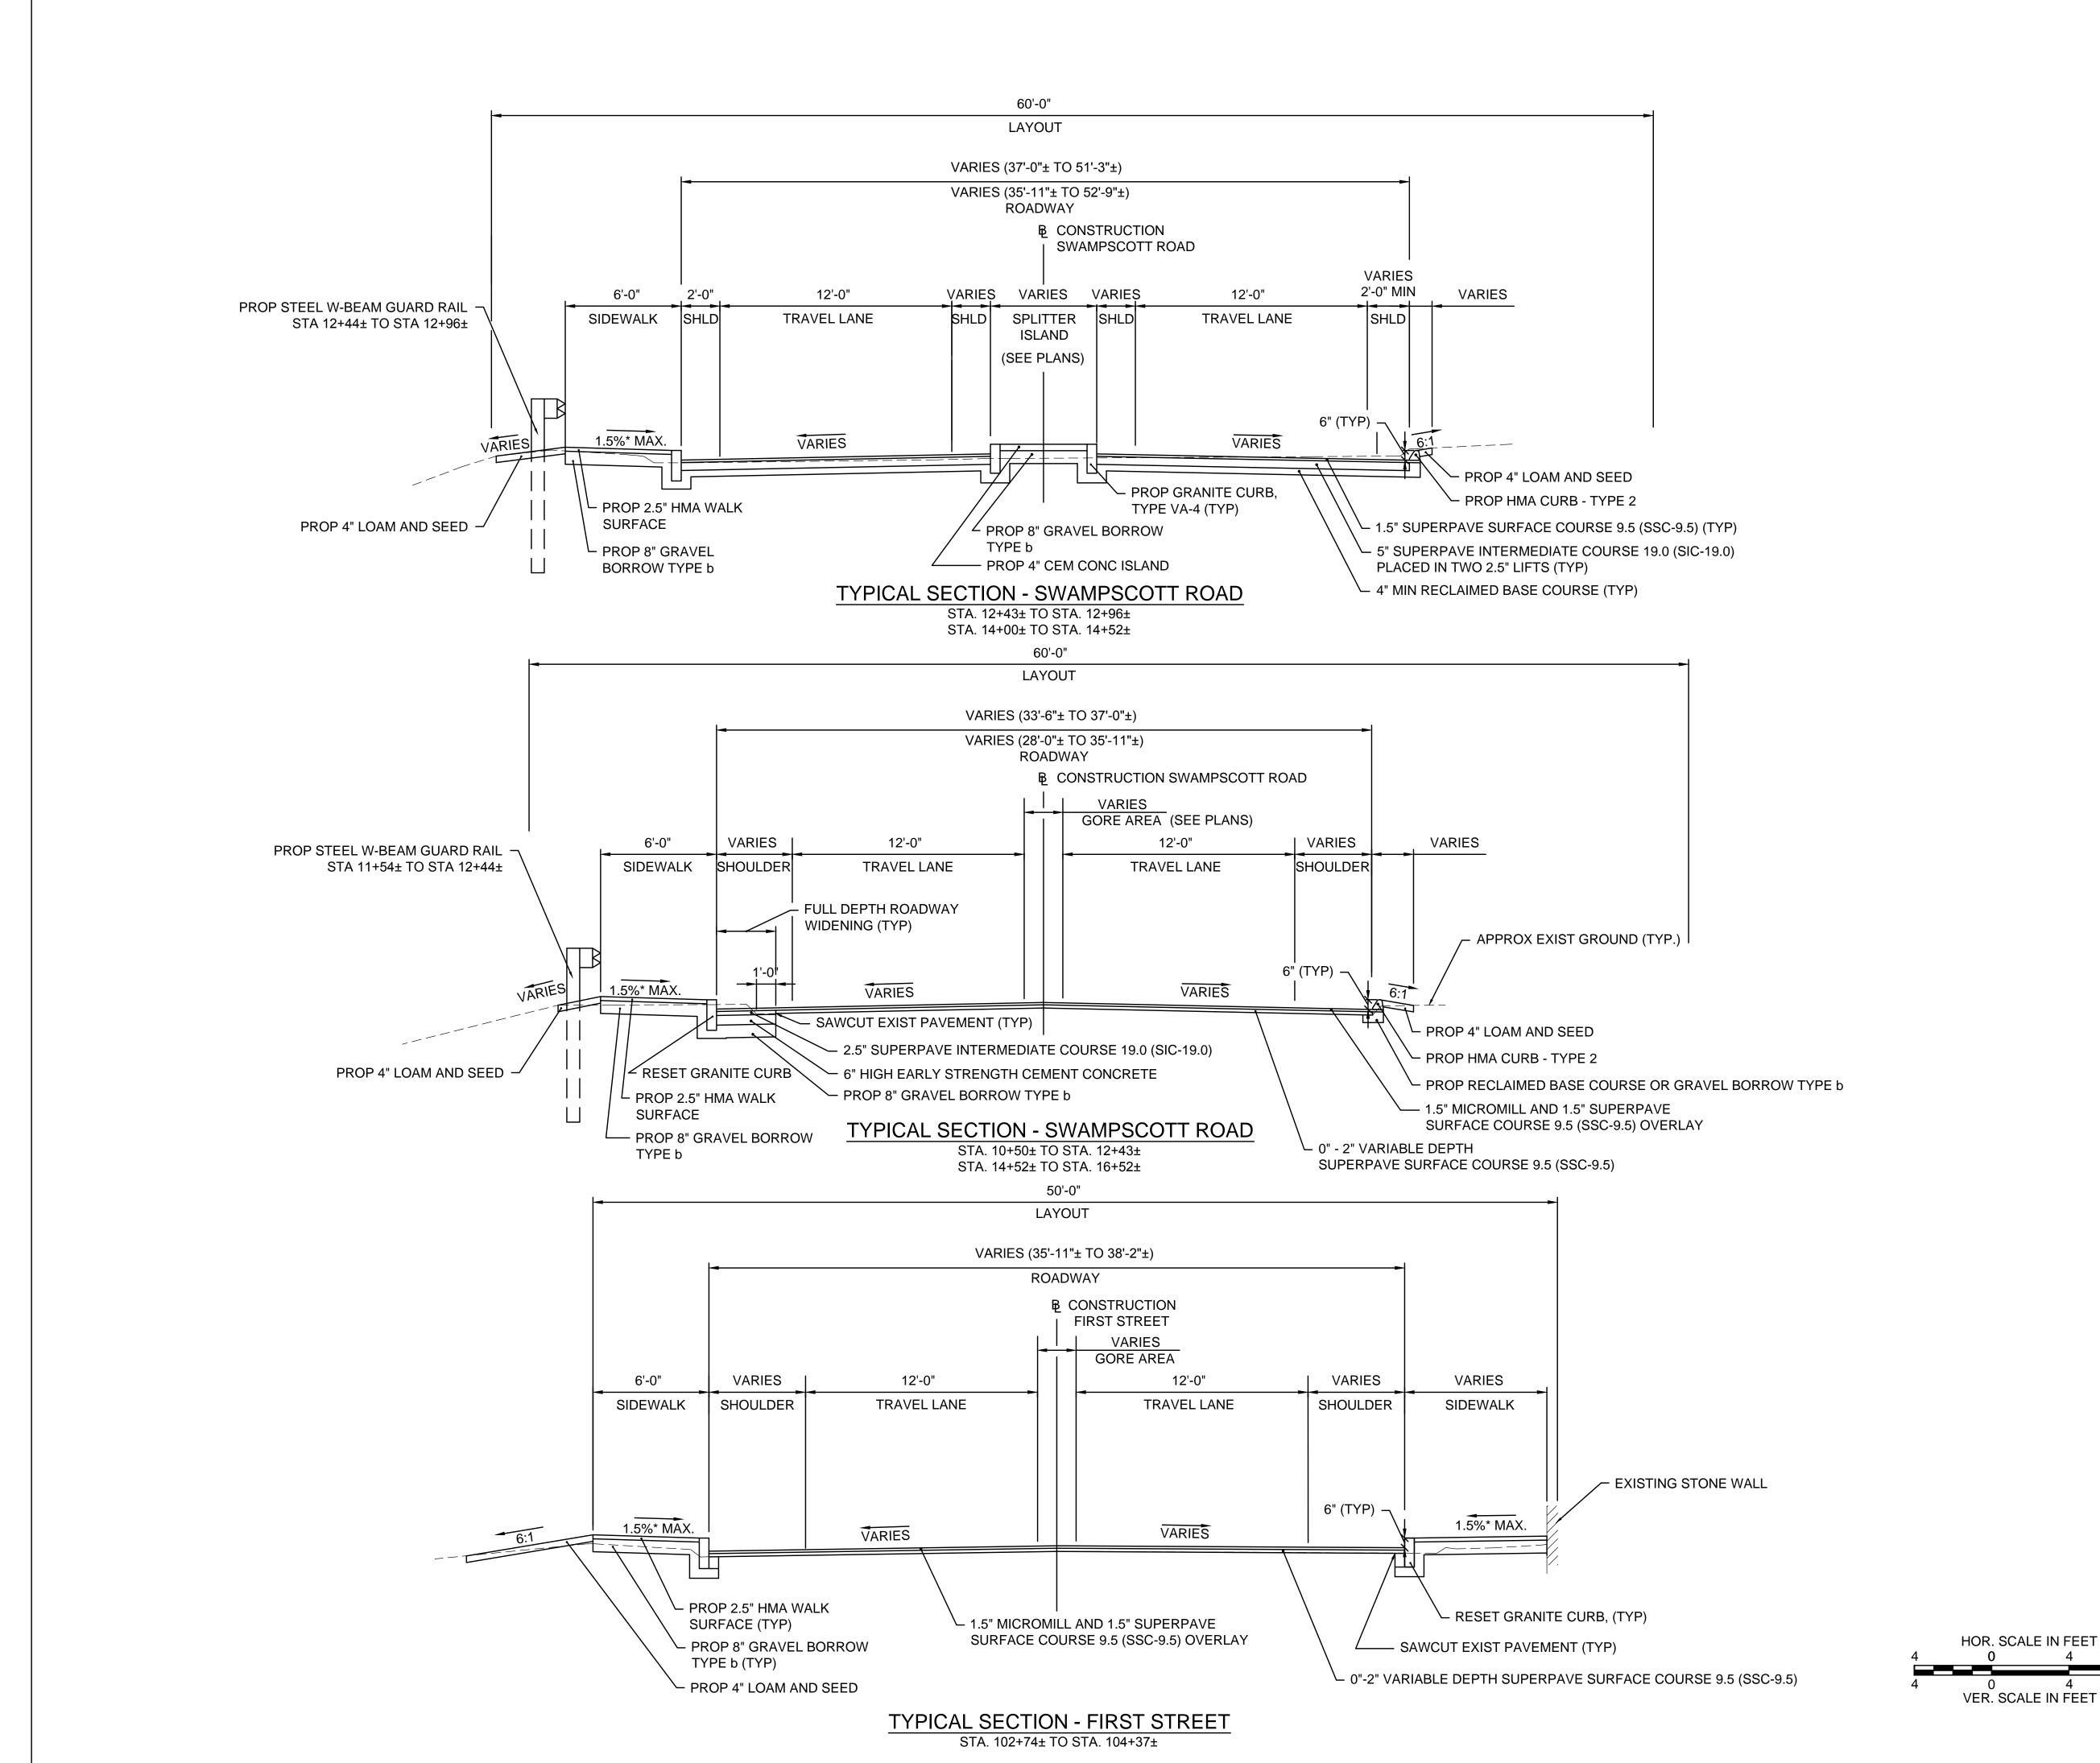



Stantec Consulting Services Inc. 5 Burlington Woods Drive, Suite 300 Burlington MA 01803 U.S.A.

Tel. 781.221.1000 www.stantec.com

Copyright Reserved

The Contractor shall verify and be responsible for all dimensions. DO NOT scale the drawing - any errors or omissions shall be reported to Stantec without delay.

The Copyrights to all designs and drawings are the property of Stantec. Reproduction or use for any purpose other than that authorized by Stantec is forbidden.

Consultants

Legend

Note

Revision

By Appd. YY.MM.I

Issued

By Appd. YY.MM.I

File Name: typical sections.dwg

SEA RAA SEA 17.09.0

Permit-Seal



Client/Project

City of Salem, MA

Swampscott Road at First Street Roundabout Construction
Salem, MA

TYPICAL SECTIONS PART - 2

Project No.


179410490

Drawing No.


Scale

1"=40'

Revision

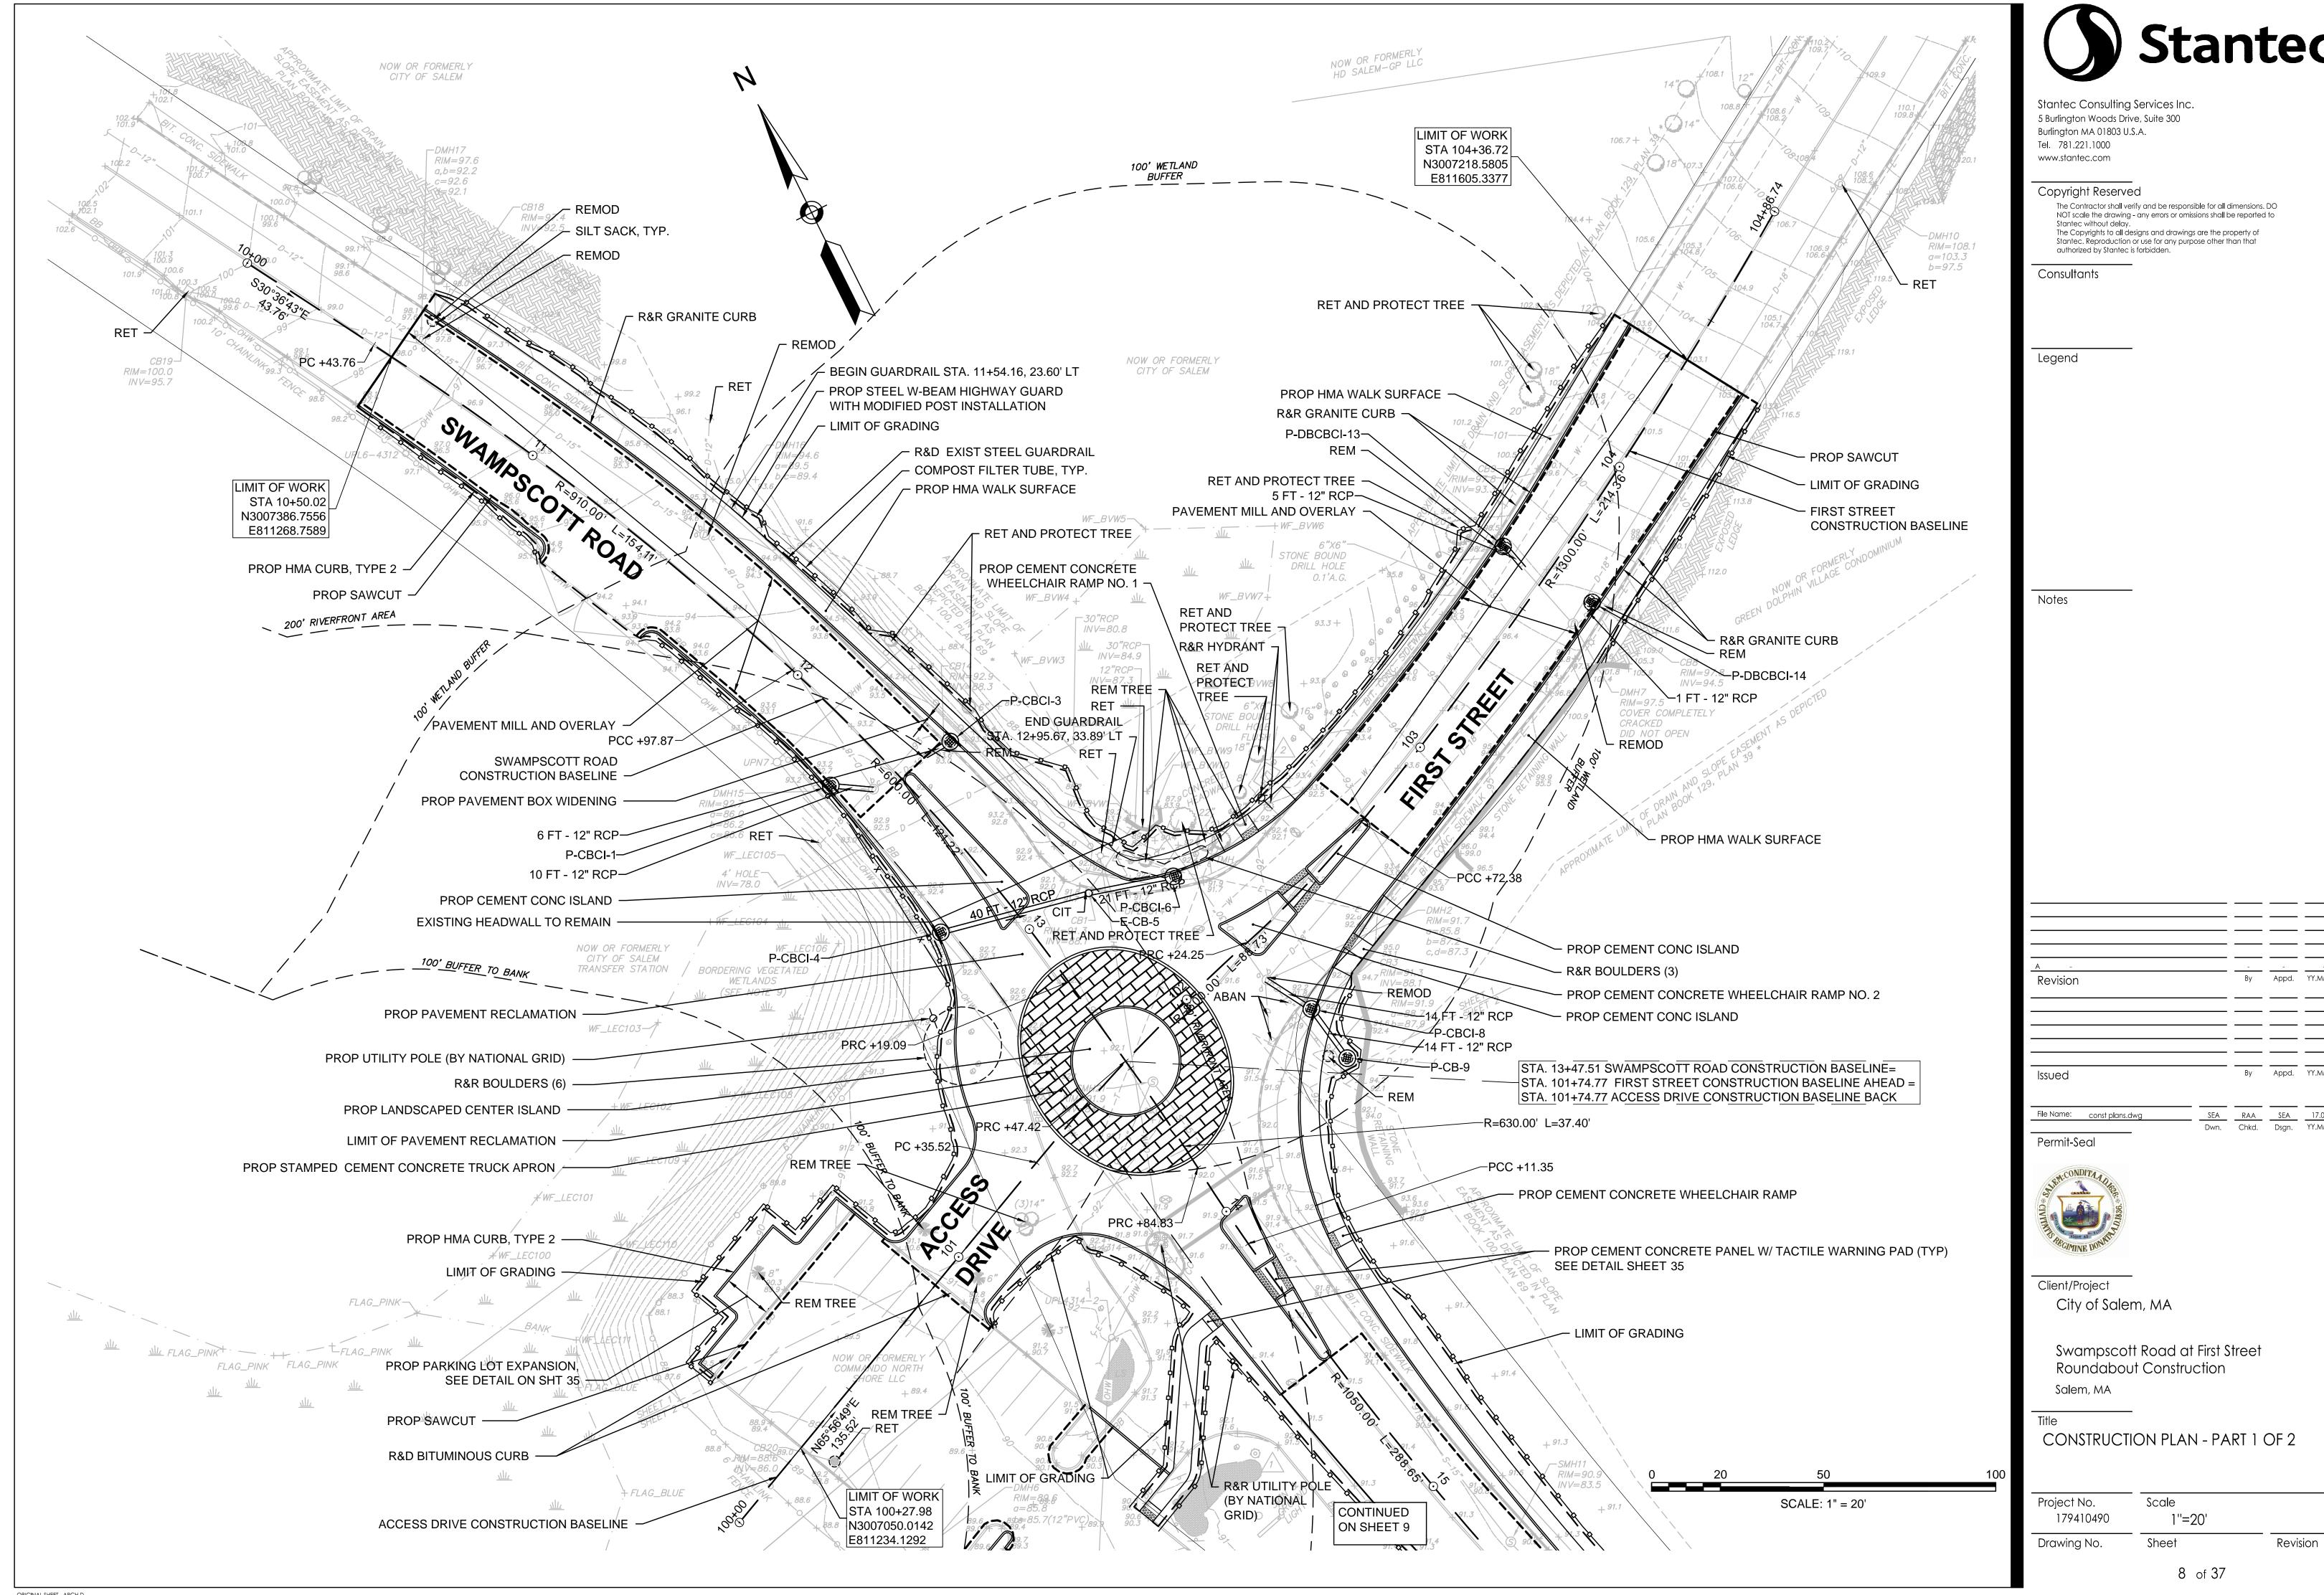

Dwn. Chkd. Dsgn. YY.MM.DD

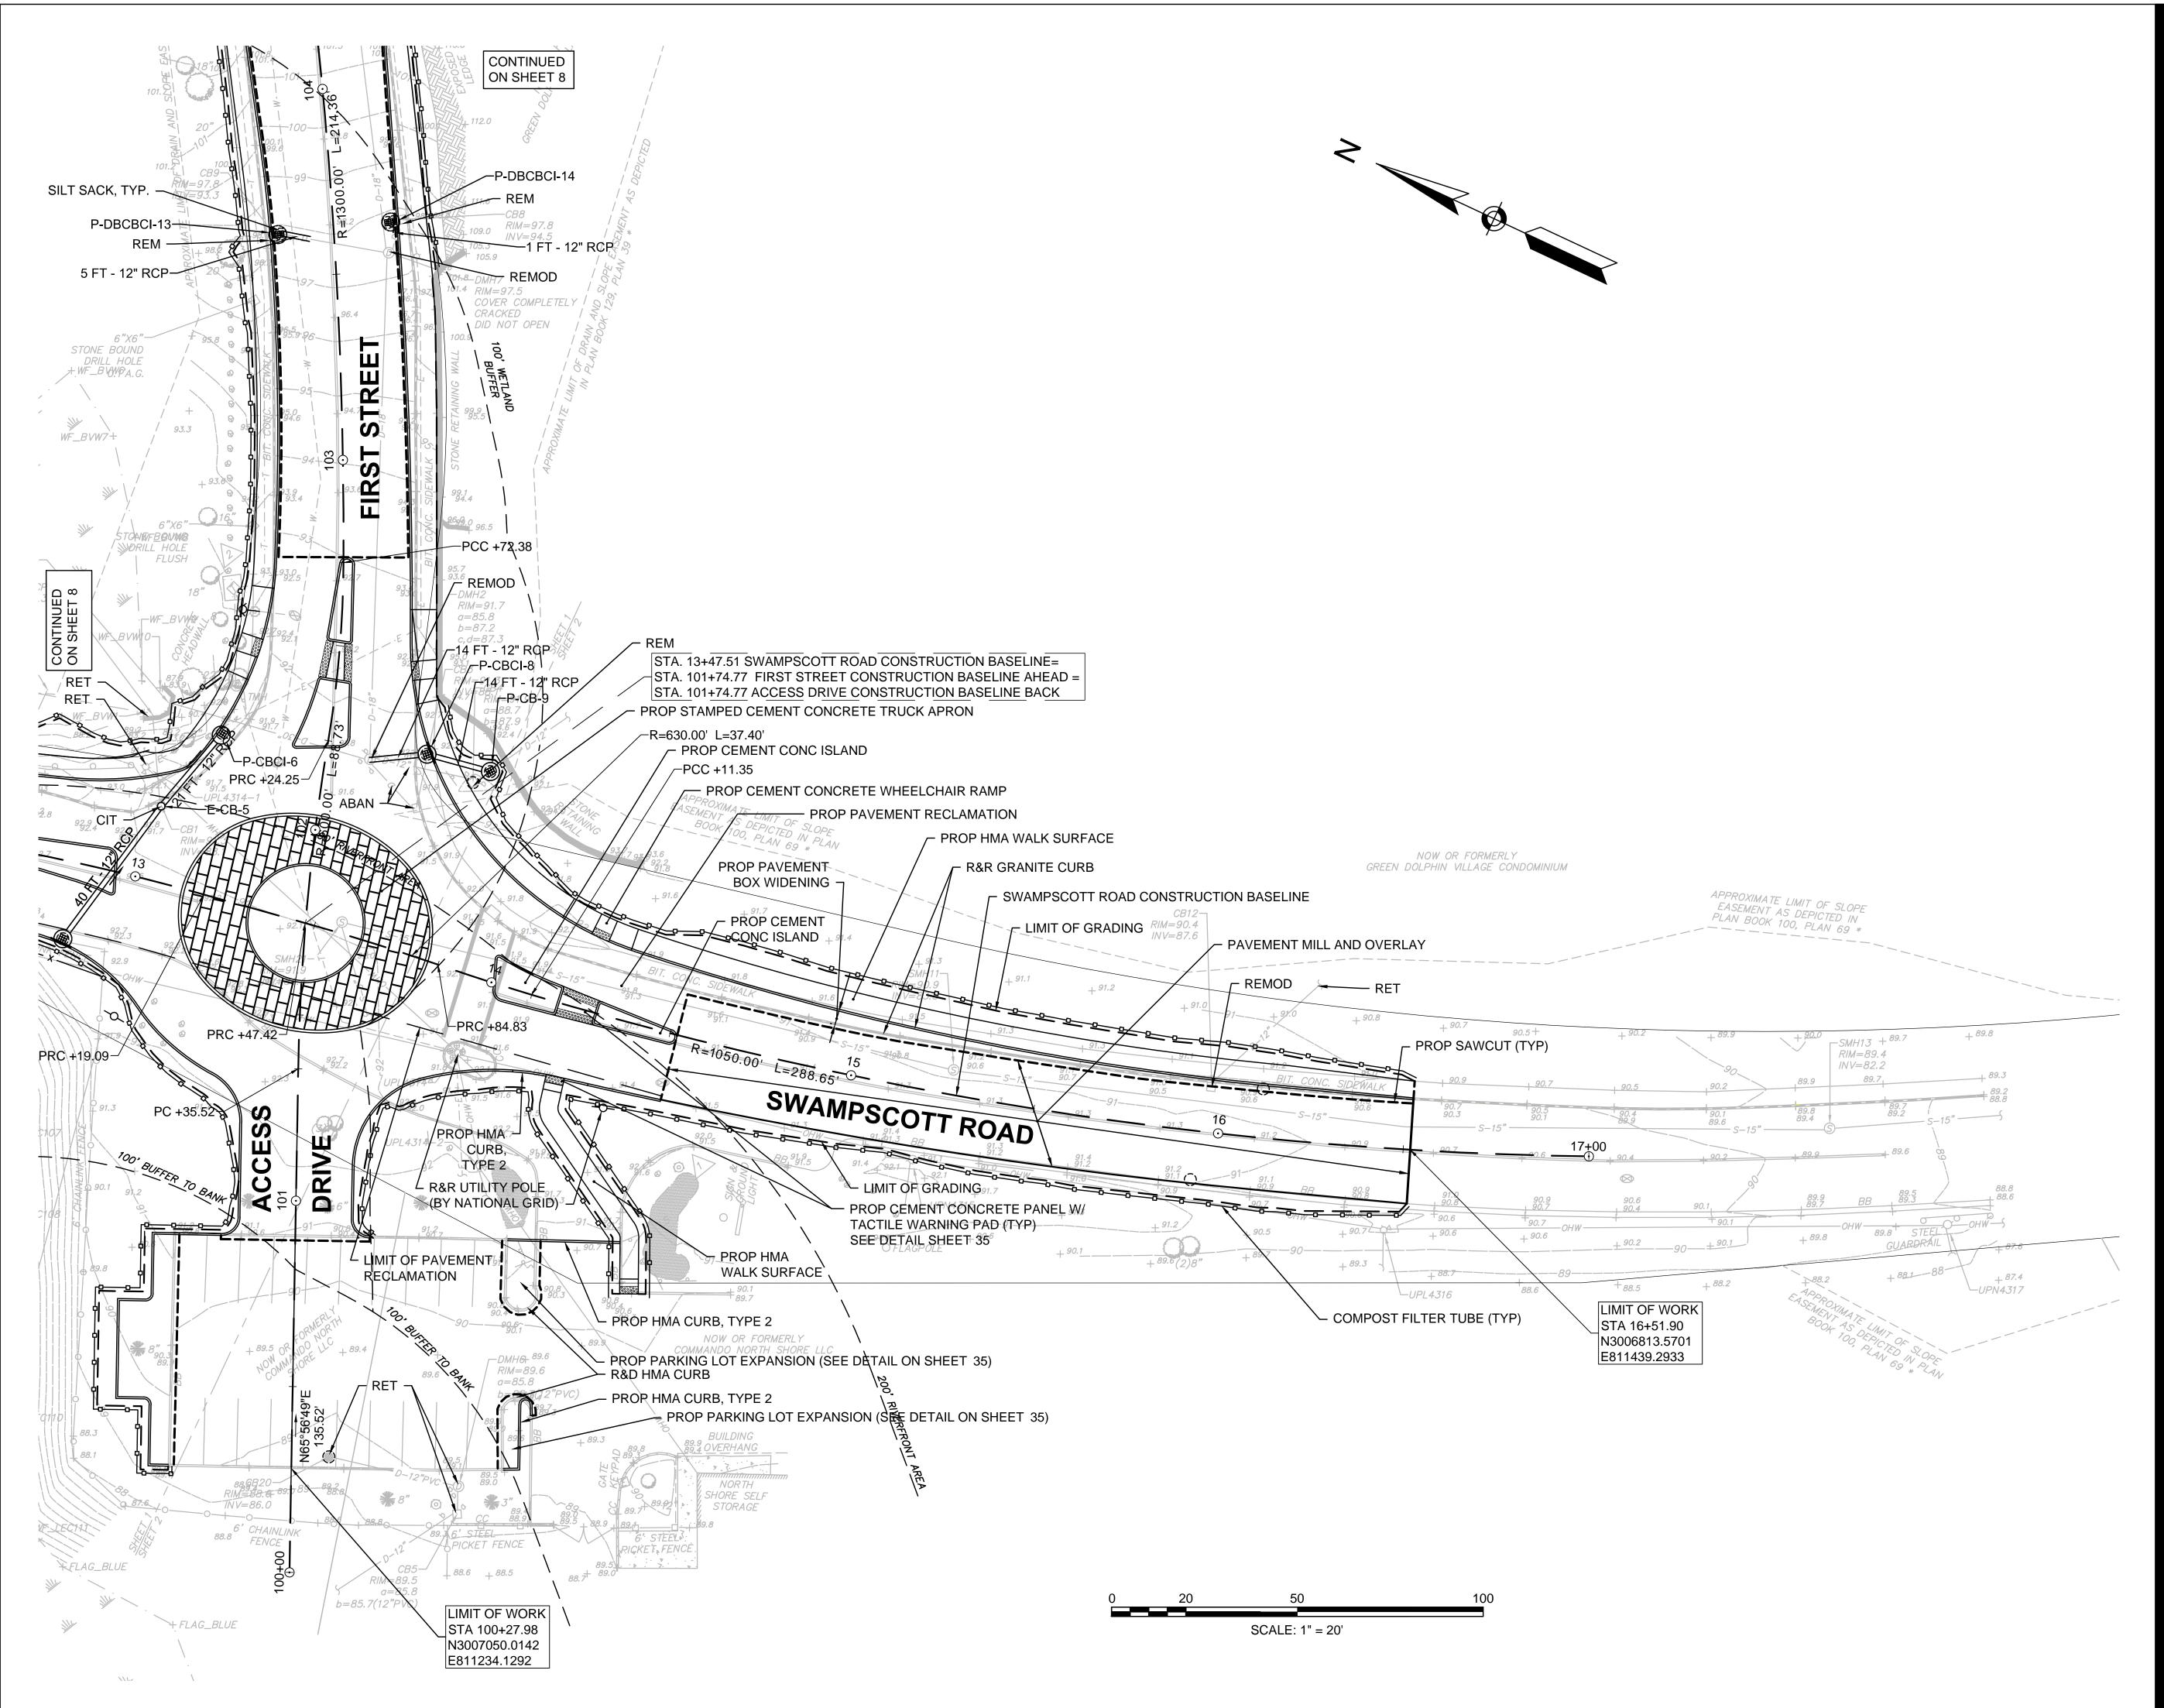



Stantec Consulting Services Inc. 5 Burlington Woods Drive, Suite 300 Burlington MA 01803 U.S.A. Tel. 781.221.1000

Copyright Reserved

www.stantec.com

The Contractor shall verify and be responsible for all dimensions. DO NOT scale the drawing - any errors or omissions shall be reported to The Copyrights to all designs and drawings are the property of Stantec. Reproduction or use for any purpose other than that authorized by Stantec is forbidden.

Consultants

File Name: const plans.dwg SEA RAA SEA 17.09.06
Dwn. Chkd. Dsgn. YY.MM.DD



Permit-Seal

Client/Project City of Salem, MA

Swampscott Road at First Street Roundabout Construction Salem, MA

CONSTRUCTION PLAN - PART 2 OF 2


Project No. Scale 179410490

Drawing No.

1''=20' Sheet

Revision

9 of 37

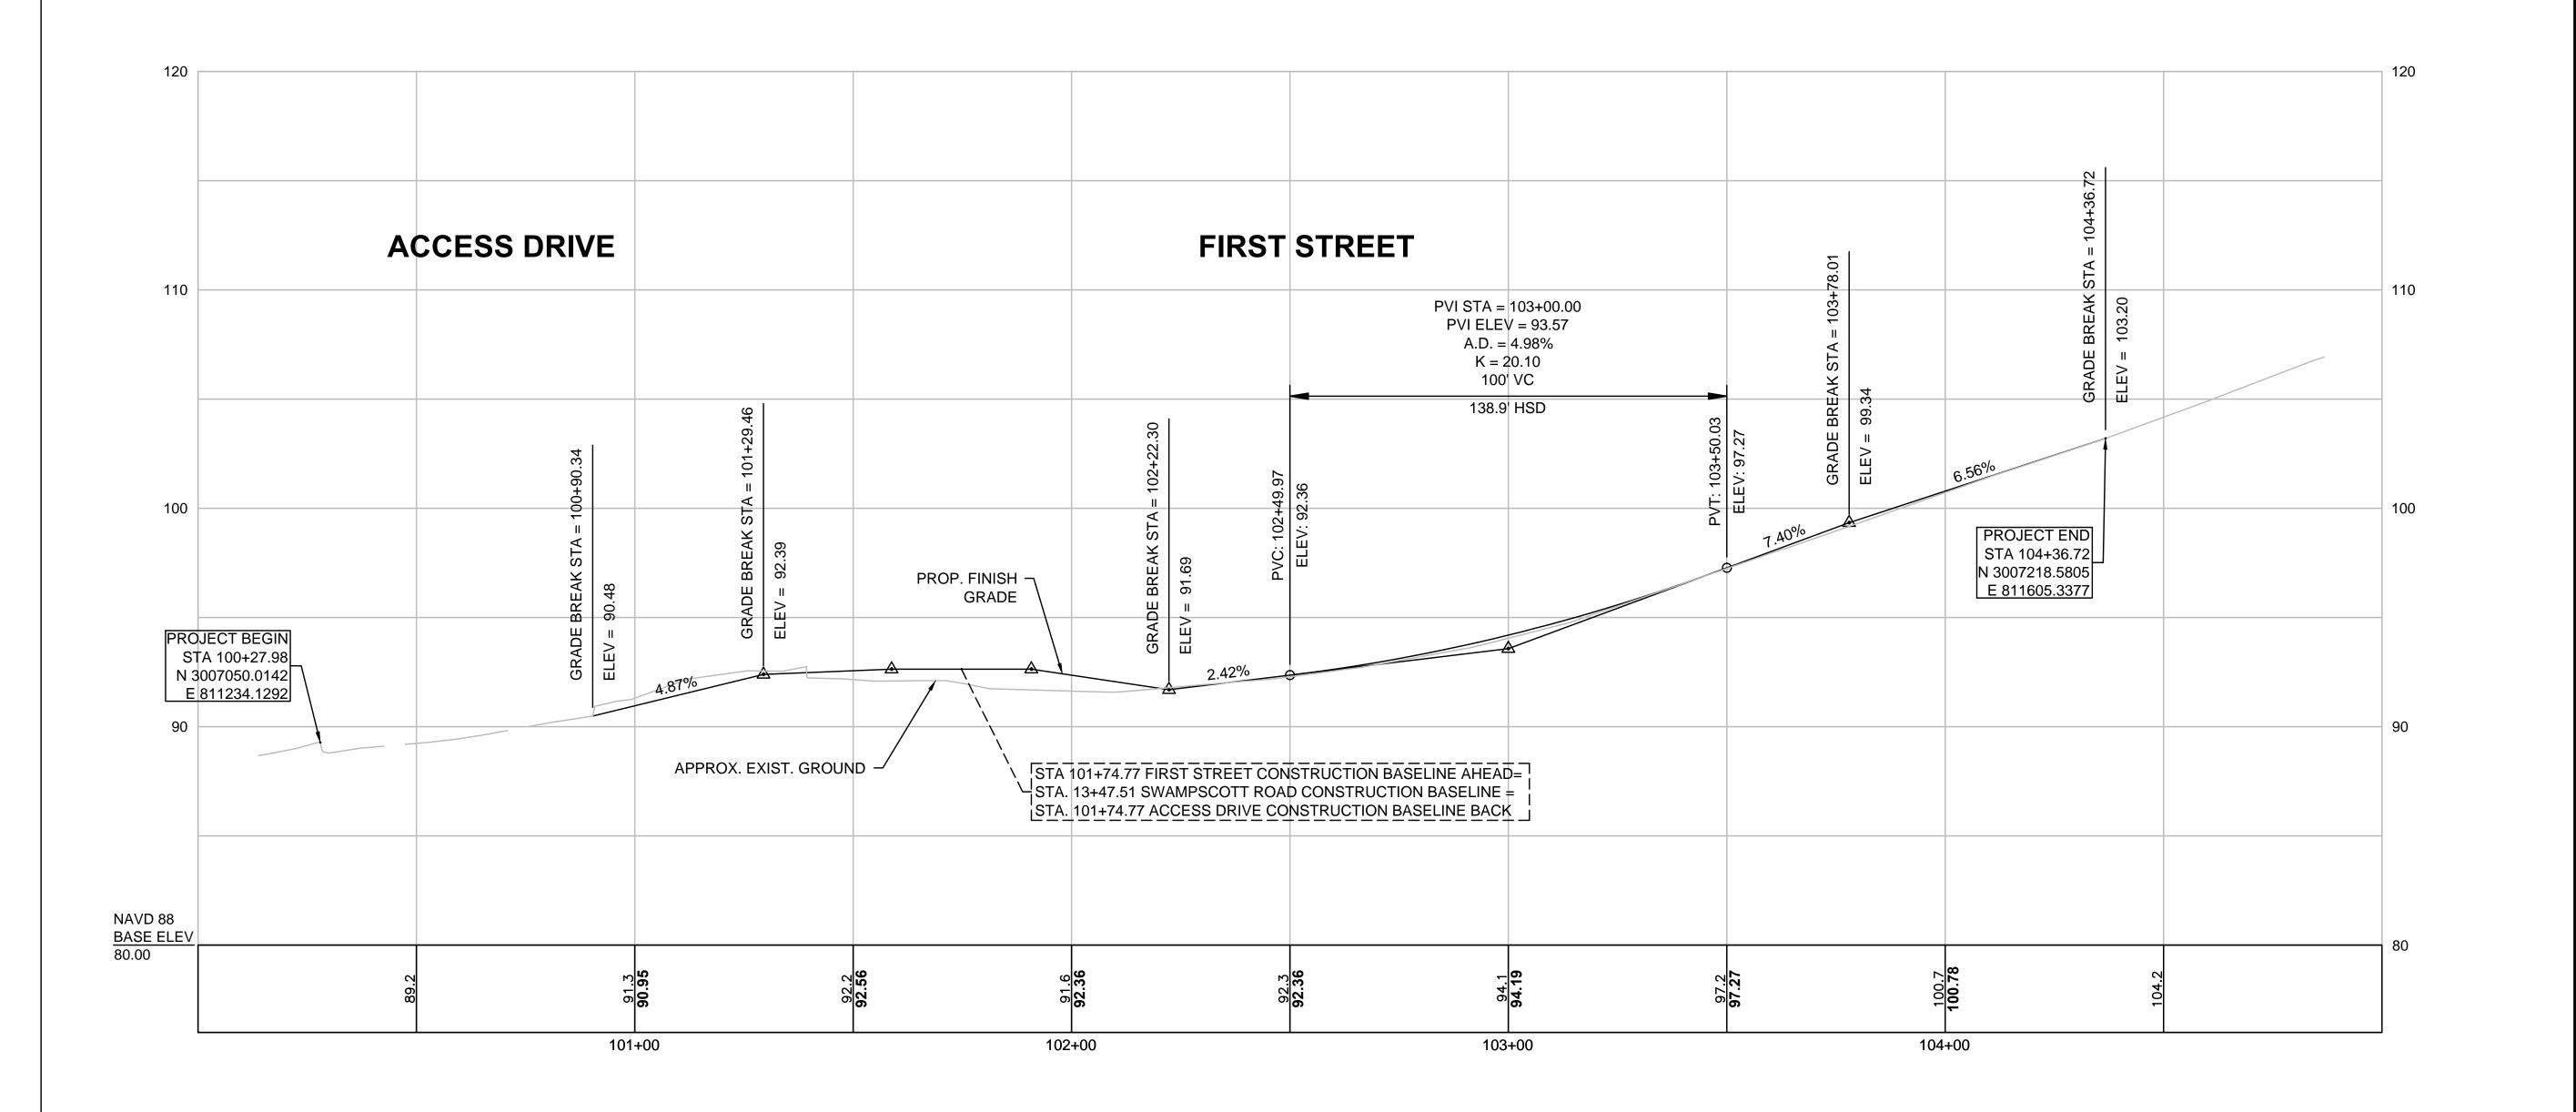



Stantec Consulting Services Inc. 5 Burlington Woods Drive, Suite 300 Burlington MA 01803 U.S.A. Tel. 781.221.1000 www.stantec.com

Copyright Reserved

The Contractor shall verify and be responsible for all dimensions. DO NOT scale the drawing - any errors or omissions shall be reported to The Copyrights to all designs and drawings are the property of Stantec. Reproduction or use for any purpose other than that authorized by Stantec is forbidden.

Consultants

By Appd. YY.MM.DD By Appd. YY.MM.DD SEA RAA SEA 17.09.06 Dwn. Chkd. Dsgn. YY.MM.DD File Name: profiles.dwg

Permit-Seal



Client/Project City of Salem, MA

> Swampscott Road at First Street Roundabout Construction Salem, MA

FIRST STREET-ACCESS DRIVE PROFILE


Project No. 179410490


Drawing No.

Scale H:1"=20' V:1"=4'

Revision

ORIGINAL SHEET - ARCH D

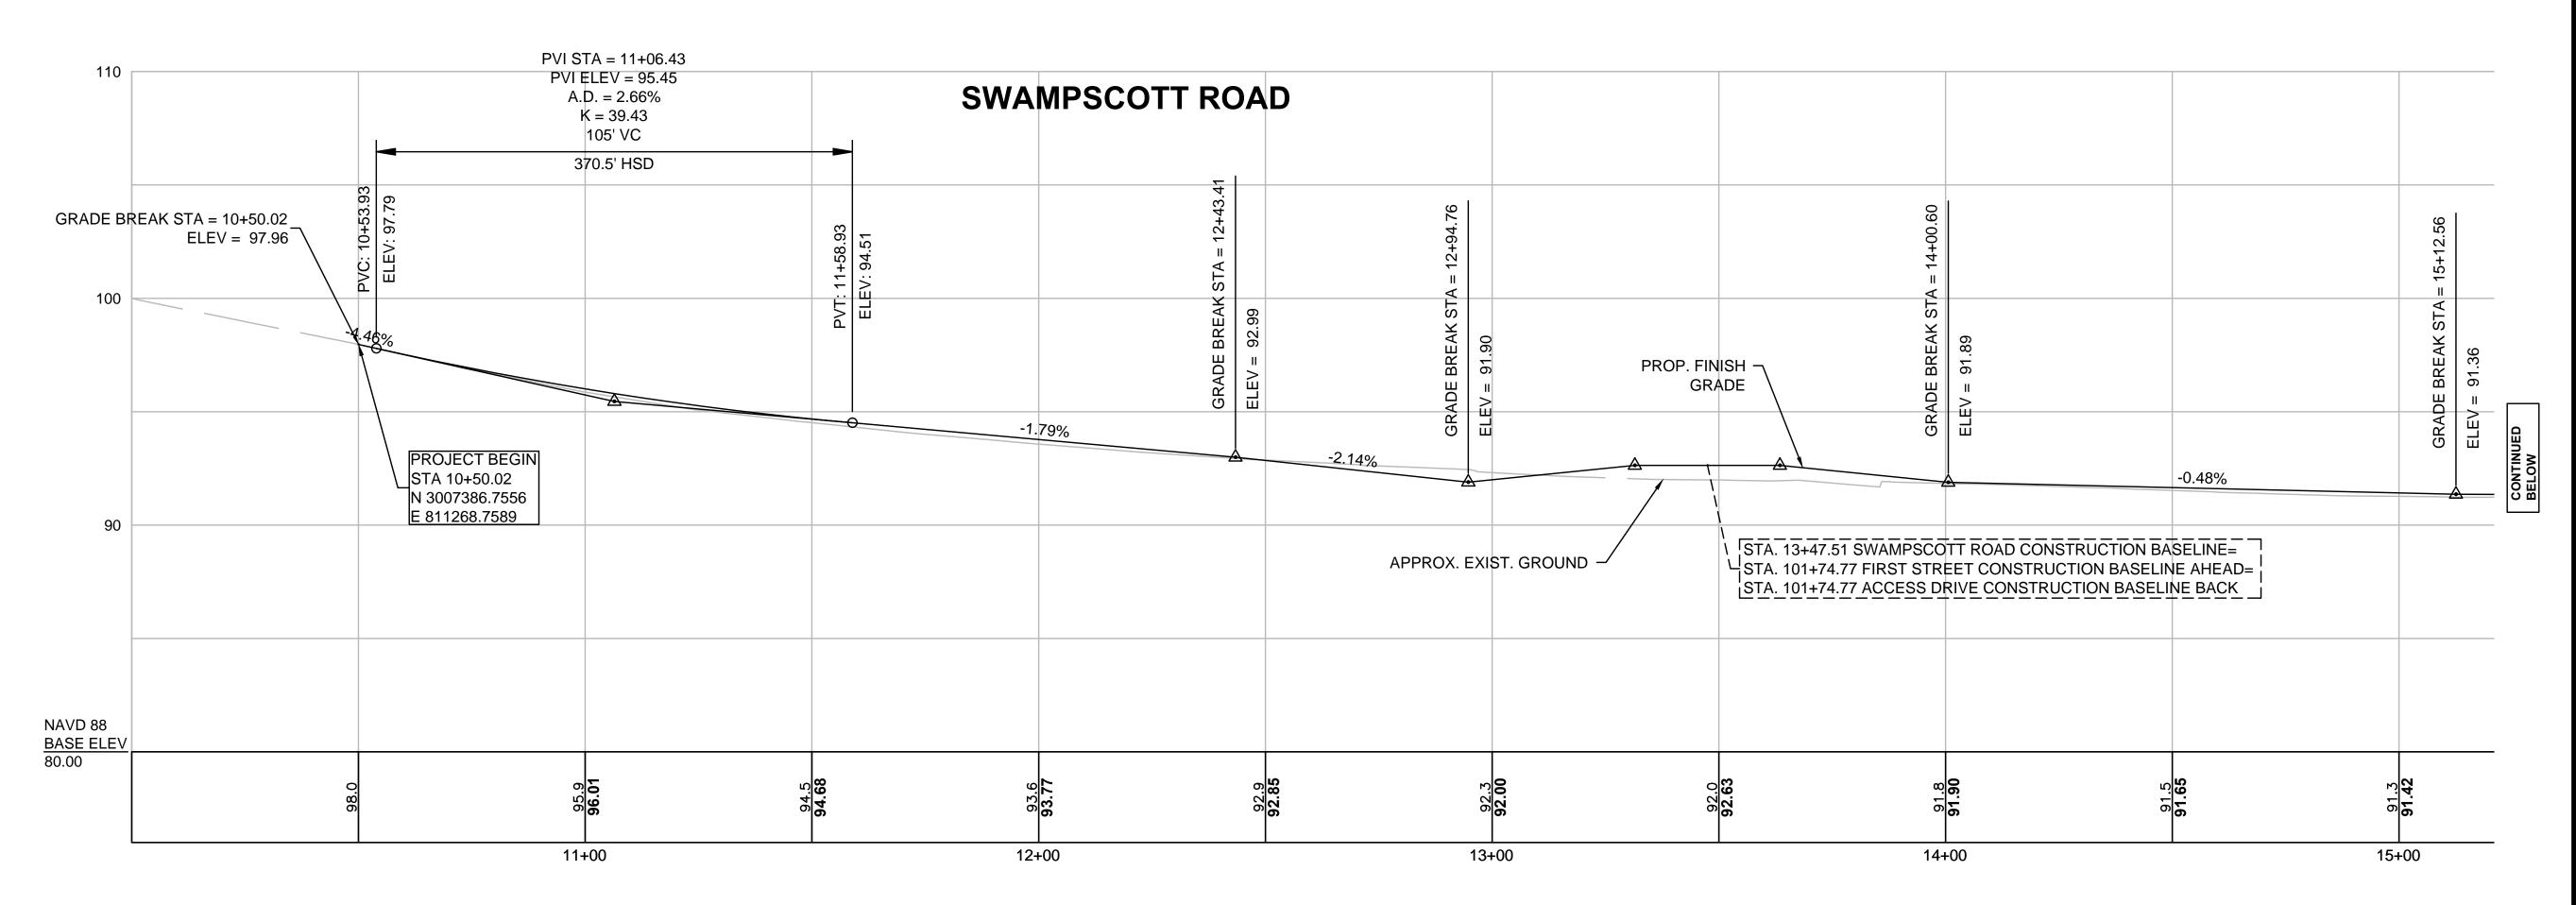

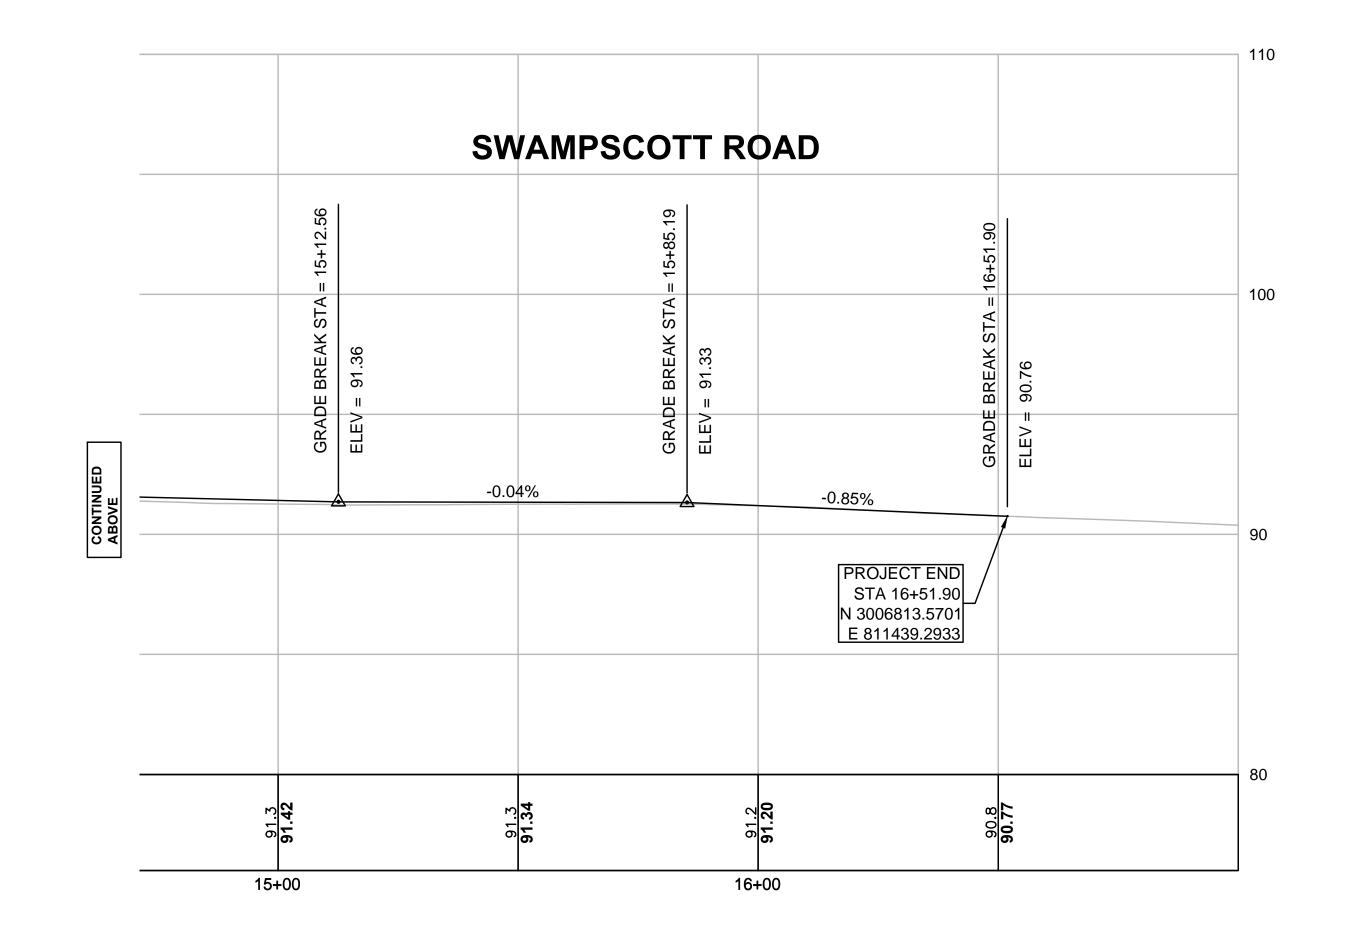



Stantec Consulting Services Inc. 5 Burlington Woods Drive, Suite 300

Burlington MA 01803 U.S.A. Tel. 781.221.1000 www.stantec.com

Copyright Reserved

The Contractor shall verify and be responsible for all dimensions. DO NOT scale the drawing - any errors or omissions shall be reported to Stantec without delay.

The Copyrights to all designs and drawings are the property of Stantec. Reproduction or use for any purpose other than that authorized by Stantec is forbidden.

Consultants

File Name: <u>profiles.dwg</u>

Permit-Seal



Client/Project City of Salem, MA

Swampscott Road at First Street Roundabout Construction Salem, MA

SWAMPSCOTT ROAD PROFILE


Project No. 179410490 Scale H:1"=20' V:1"=4'

Drawing No.

Revision

11 of 37

ORIGINAL SHEET - ARCH D

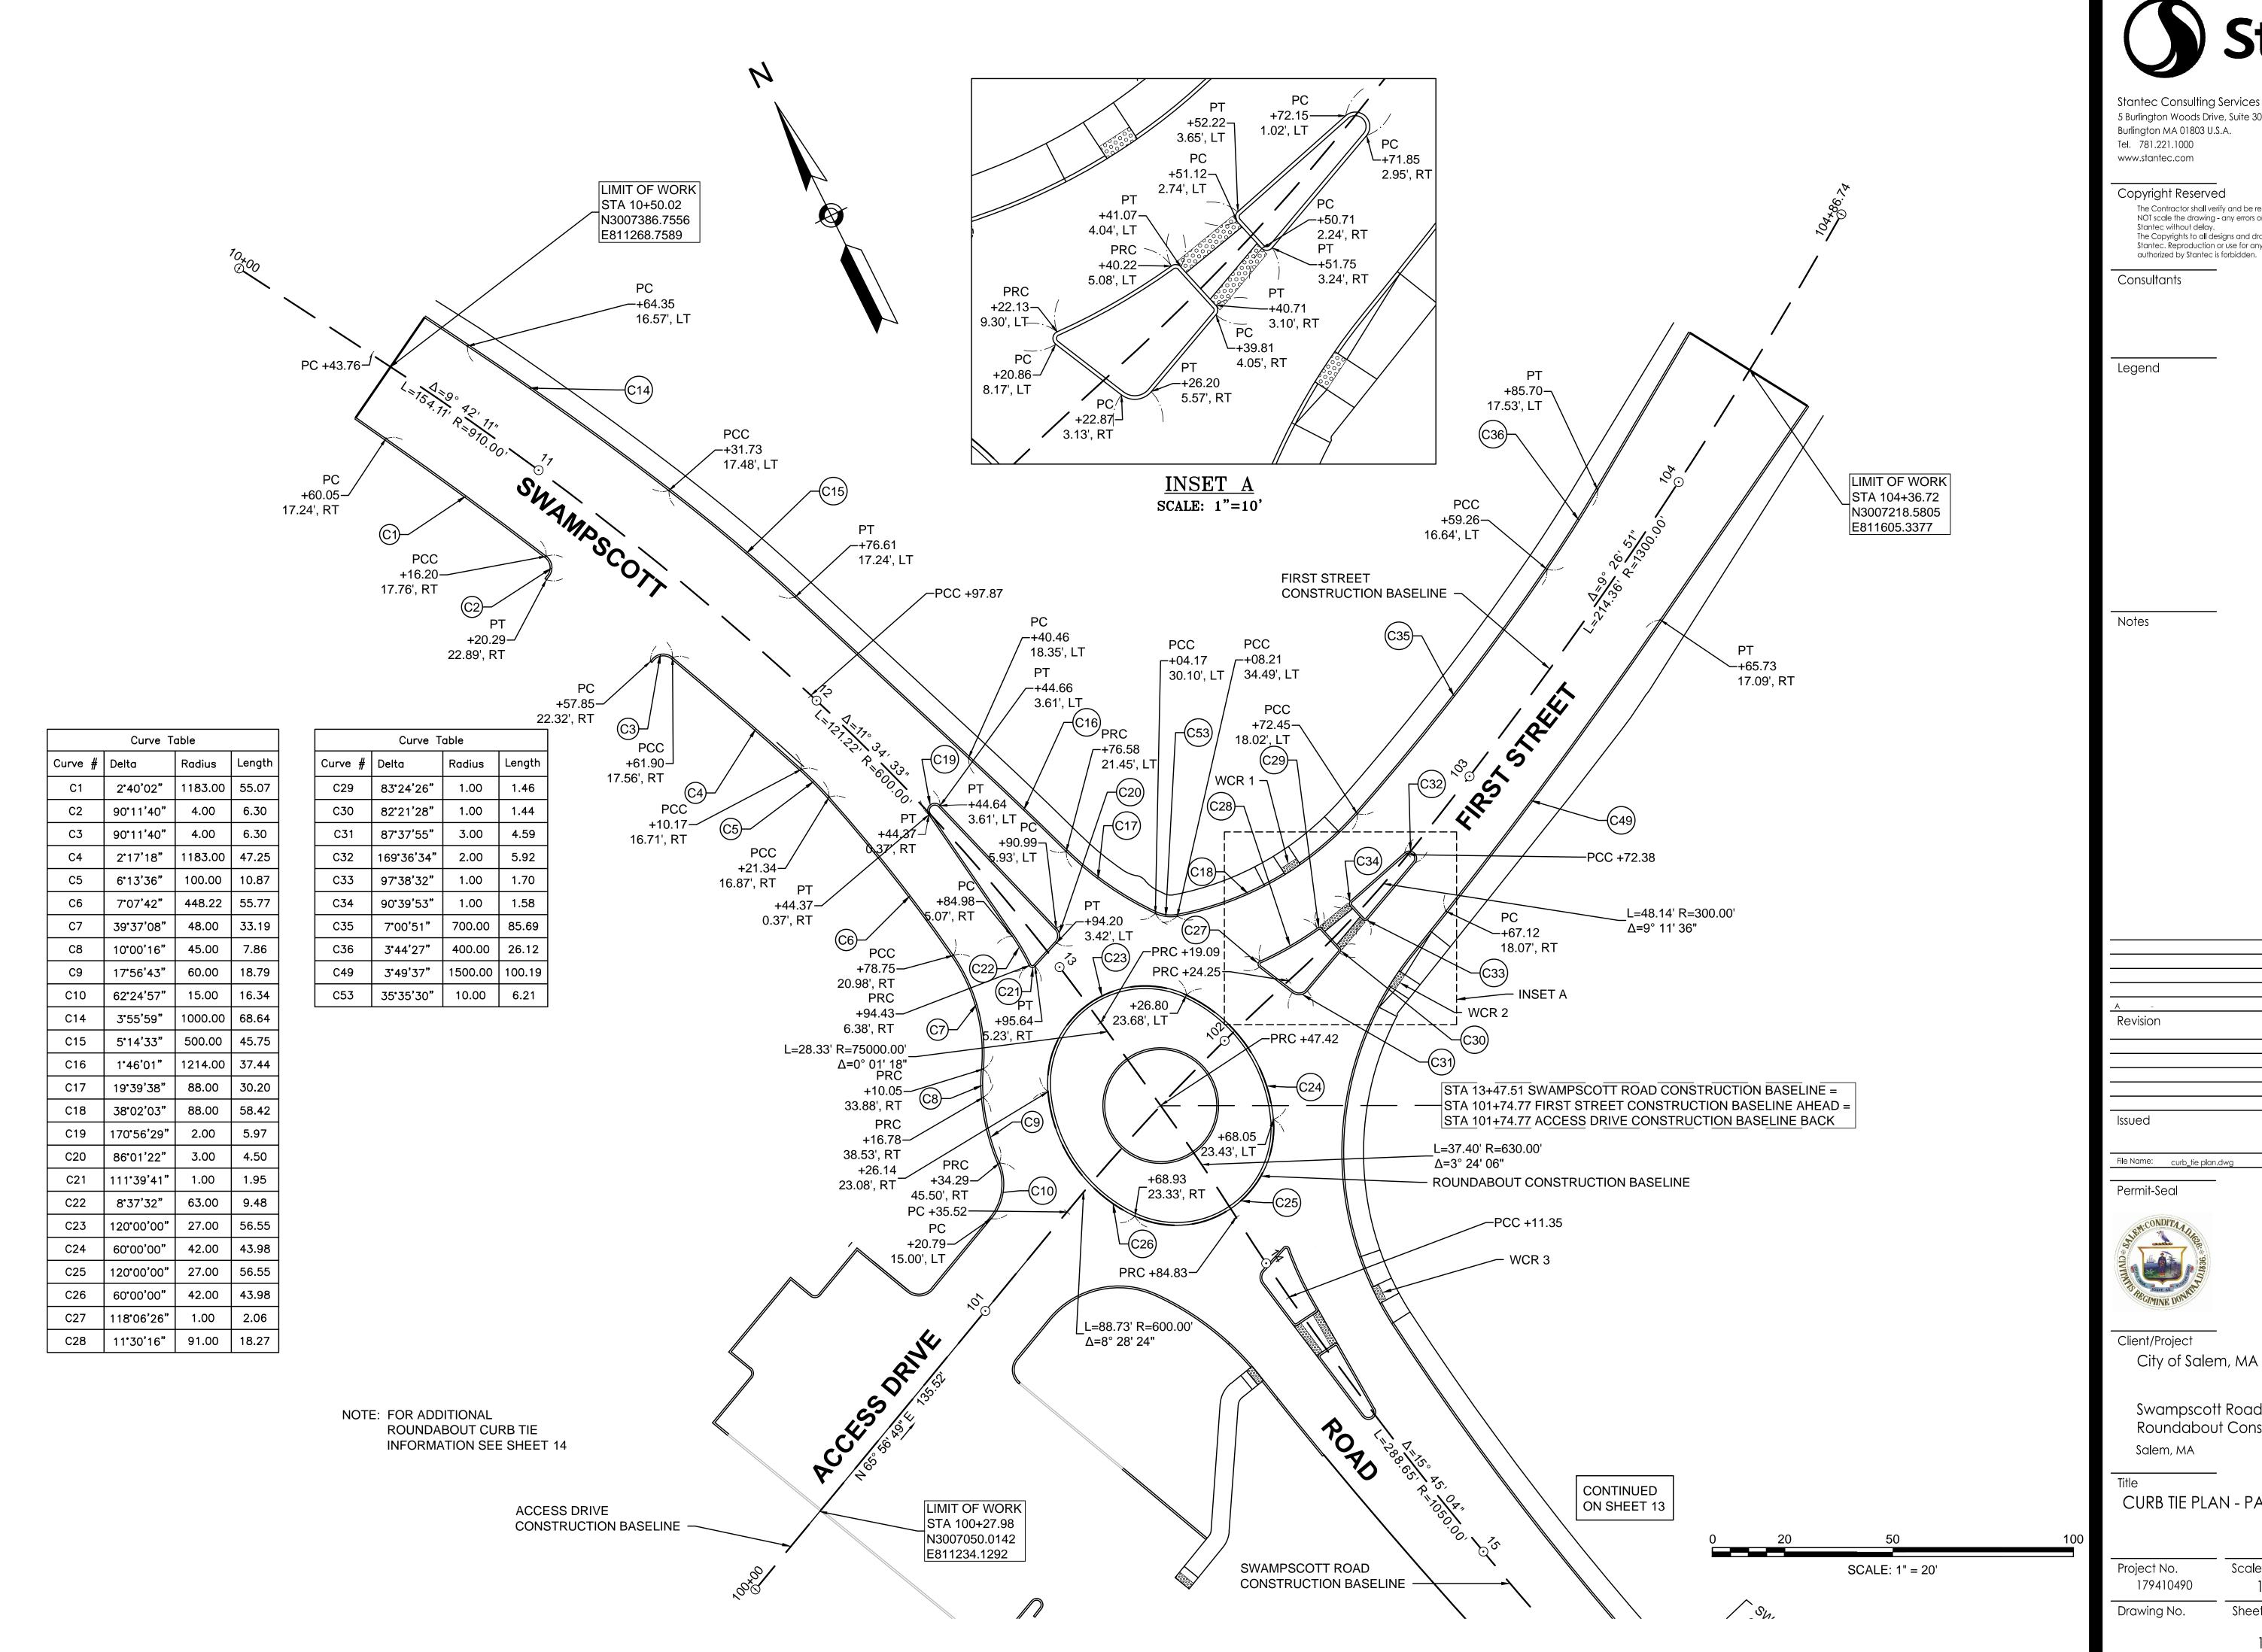



Stantec Consulting Services Inc. 5 Burlington Woods Drive, Suite 300

> The Contractor shall verify and be responsible for all dimensions. DO NOT scale the drawing - any errors or omissions shall be reported to The Copyrights to all designs and drawings are the property of Stantec. Reproduction or use for any purpose other than that


Appd. By Appd. YY.MM.DD SEA RAA SEA 17.09.06
Dwn. Chkd. Dsgn. YY.MM.DD File Name: <u>curb_tie plan.dwg</u>

Swampscott Road at First Street Roundabout Construction

CURB TIE PLAN - PART 1 OF 3

Scale 1''=20' Sheet Revision

12 of 37

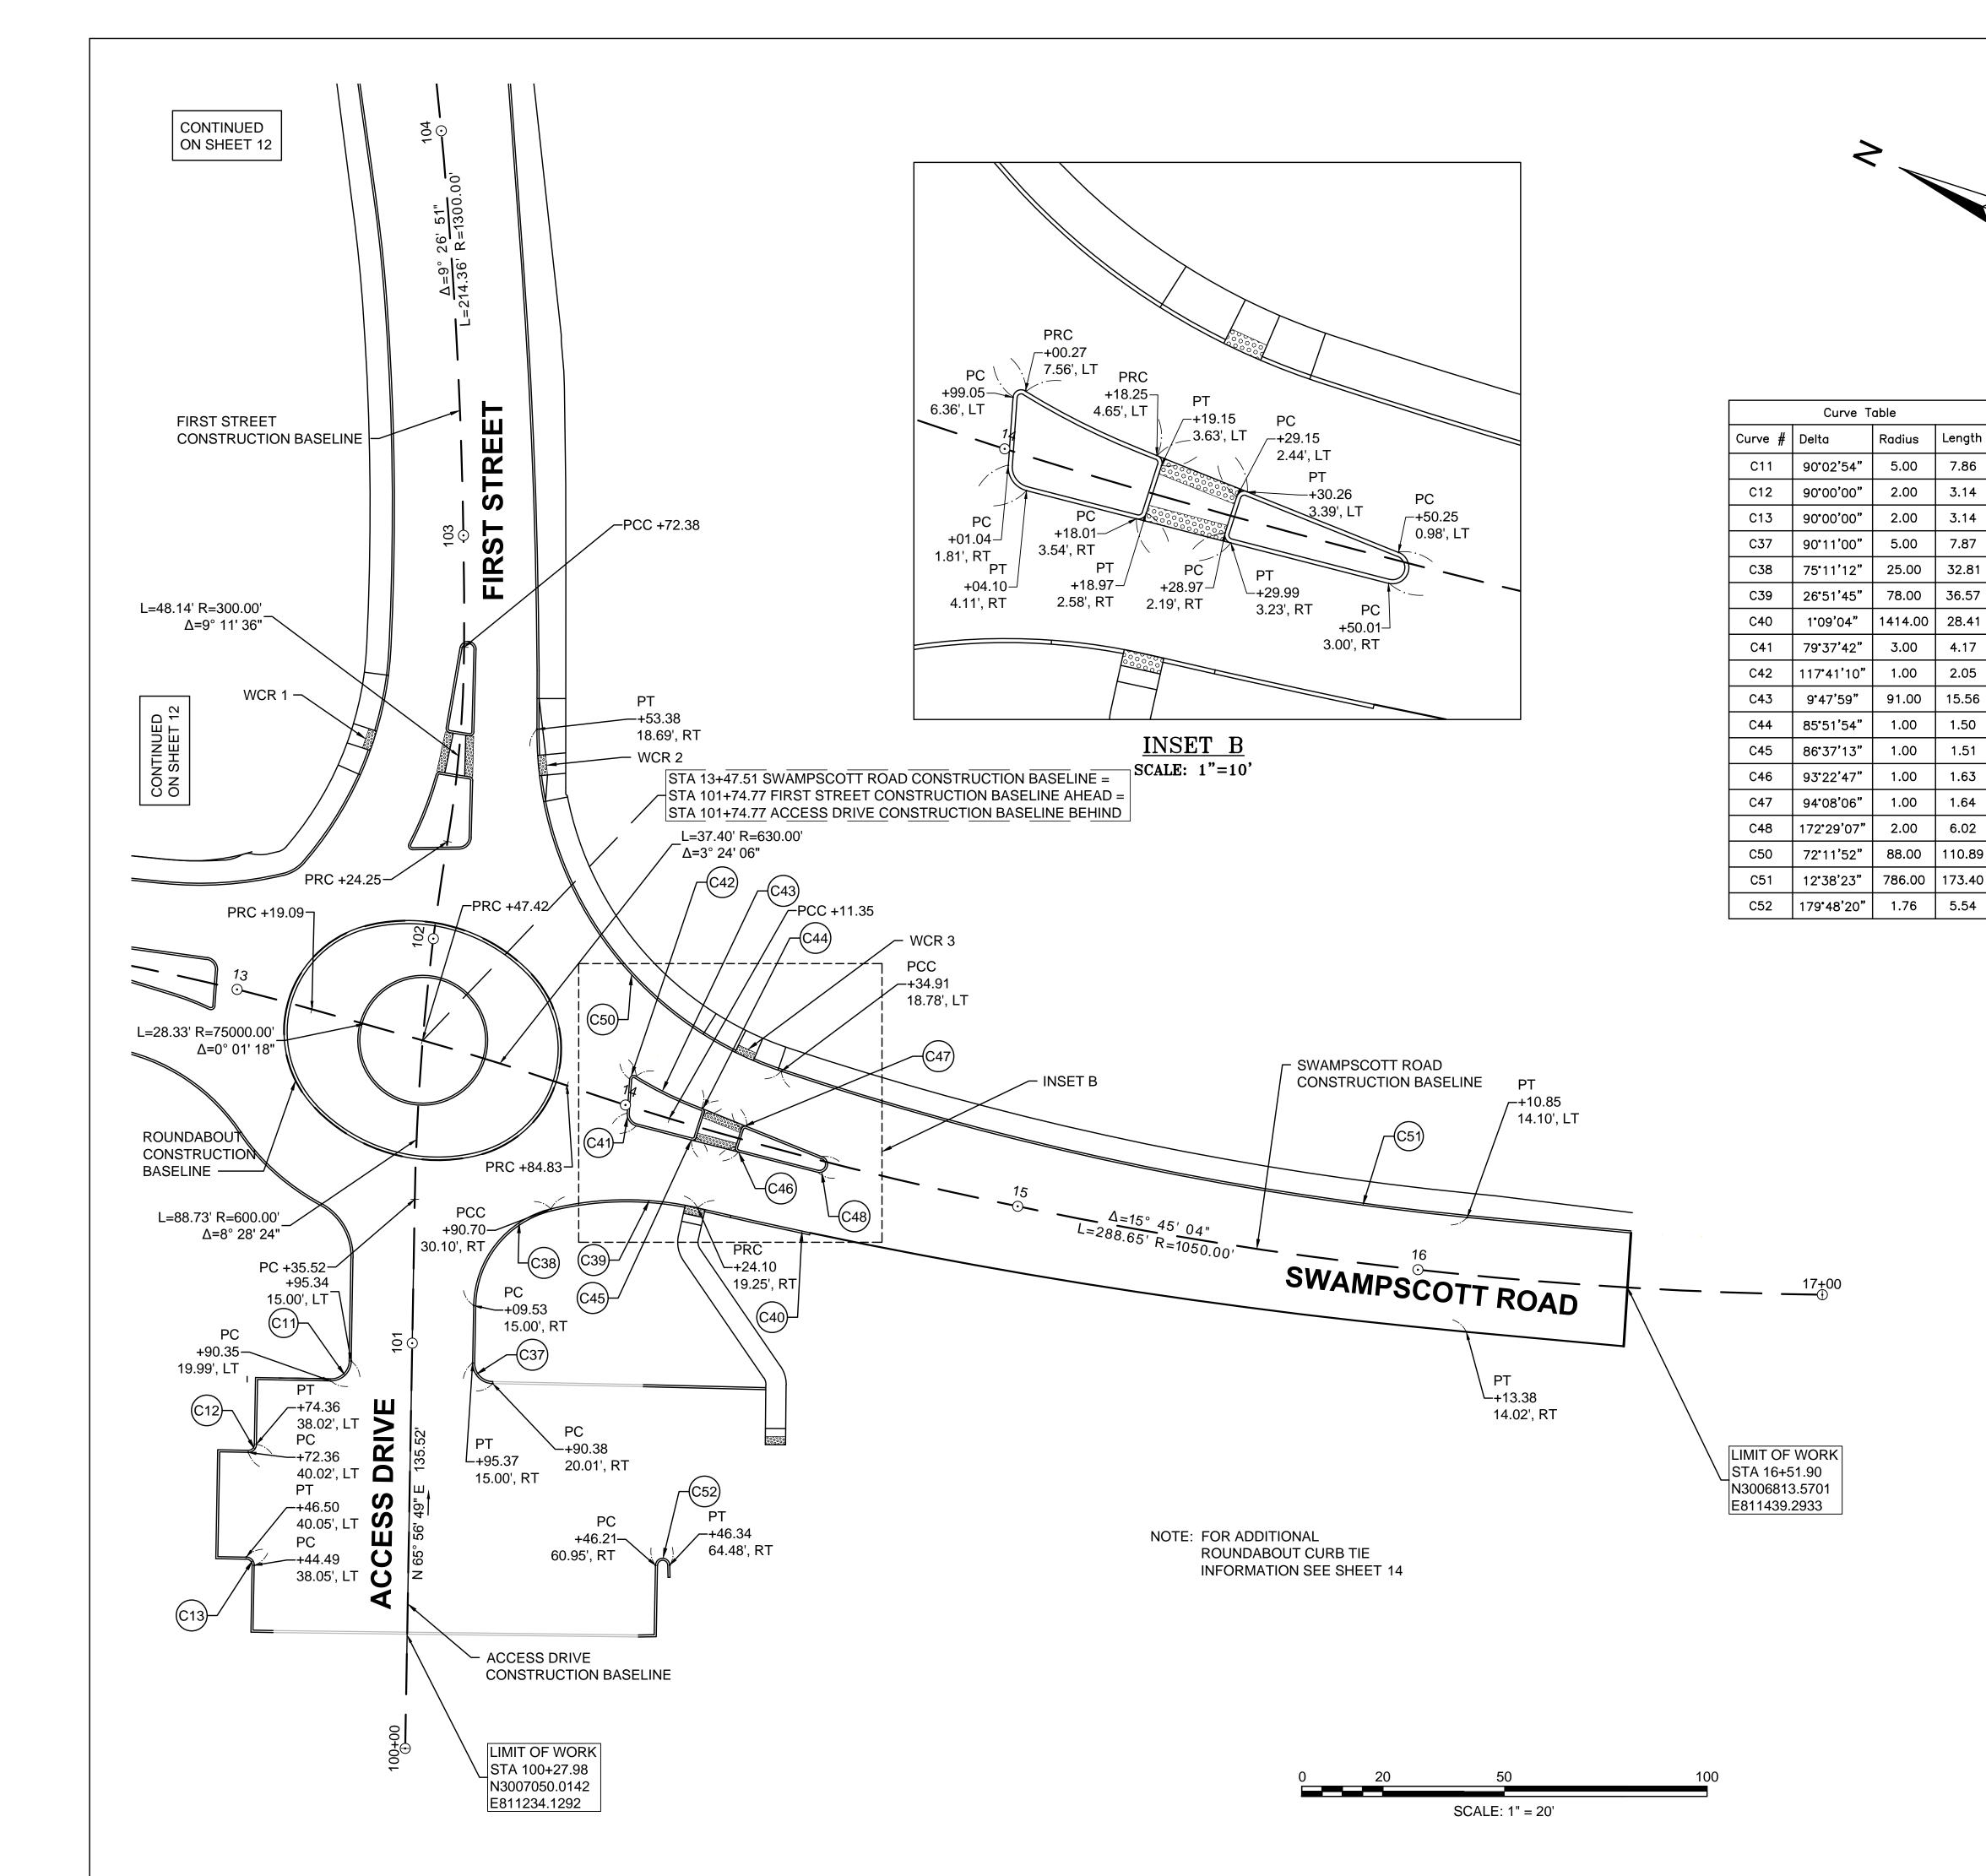



Stantec Consulting Services Inc. 5 Burlington Woods Drive, Suite 300 Burlington MA 01803 U.S.A. Tel. 781.221.1000 www.stantec.com

Copyright Reserved

The Contractor shall verify and be responsible for all dimensions. DO NOT scale the drawing - any errors or omissions shall be reported to Stantec without delay.

The Copyrights to all designs and drawings are the property of Stantec. Reproduction or use for any purpose other than that authorized by Stantec is forbidden.

Consultants

Legend

Note



Client/Project
City of Salem, MA


Swampscott Road at First Street Roundabout Construction Salem, MA

Title

CURB TIE PLAN - PART 2 OF 3


Project No. Scale
179410490 1"=20'


Drawing No. Sheet Revision

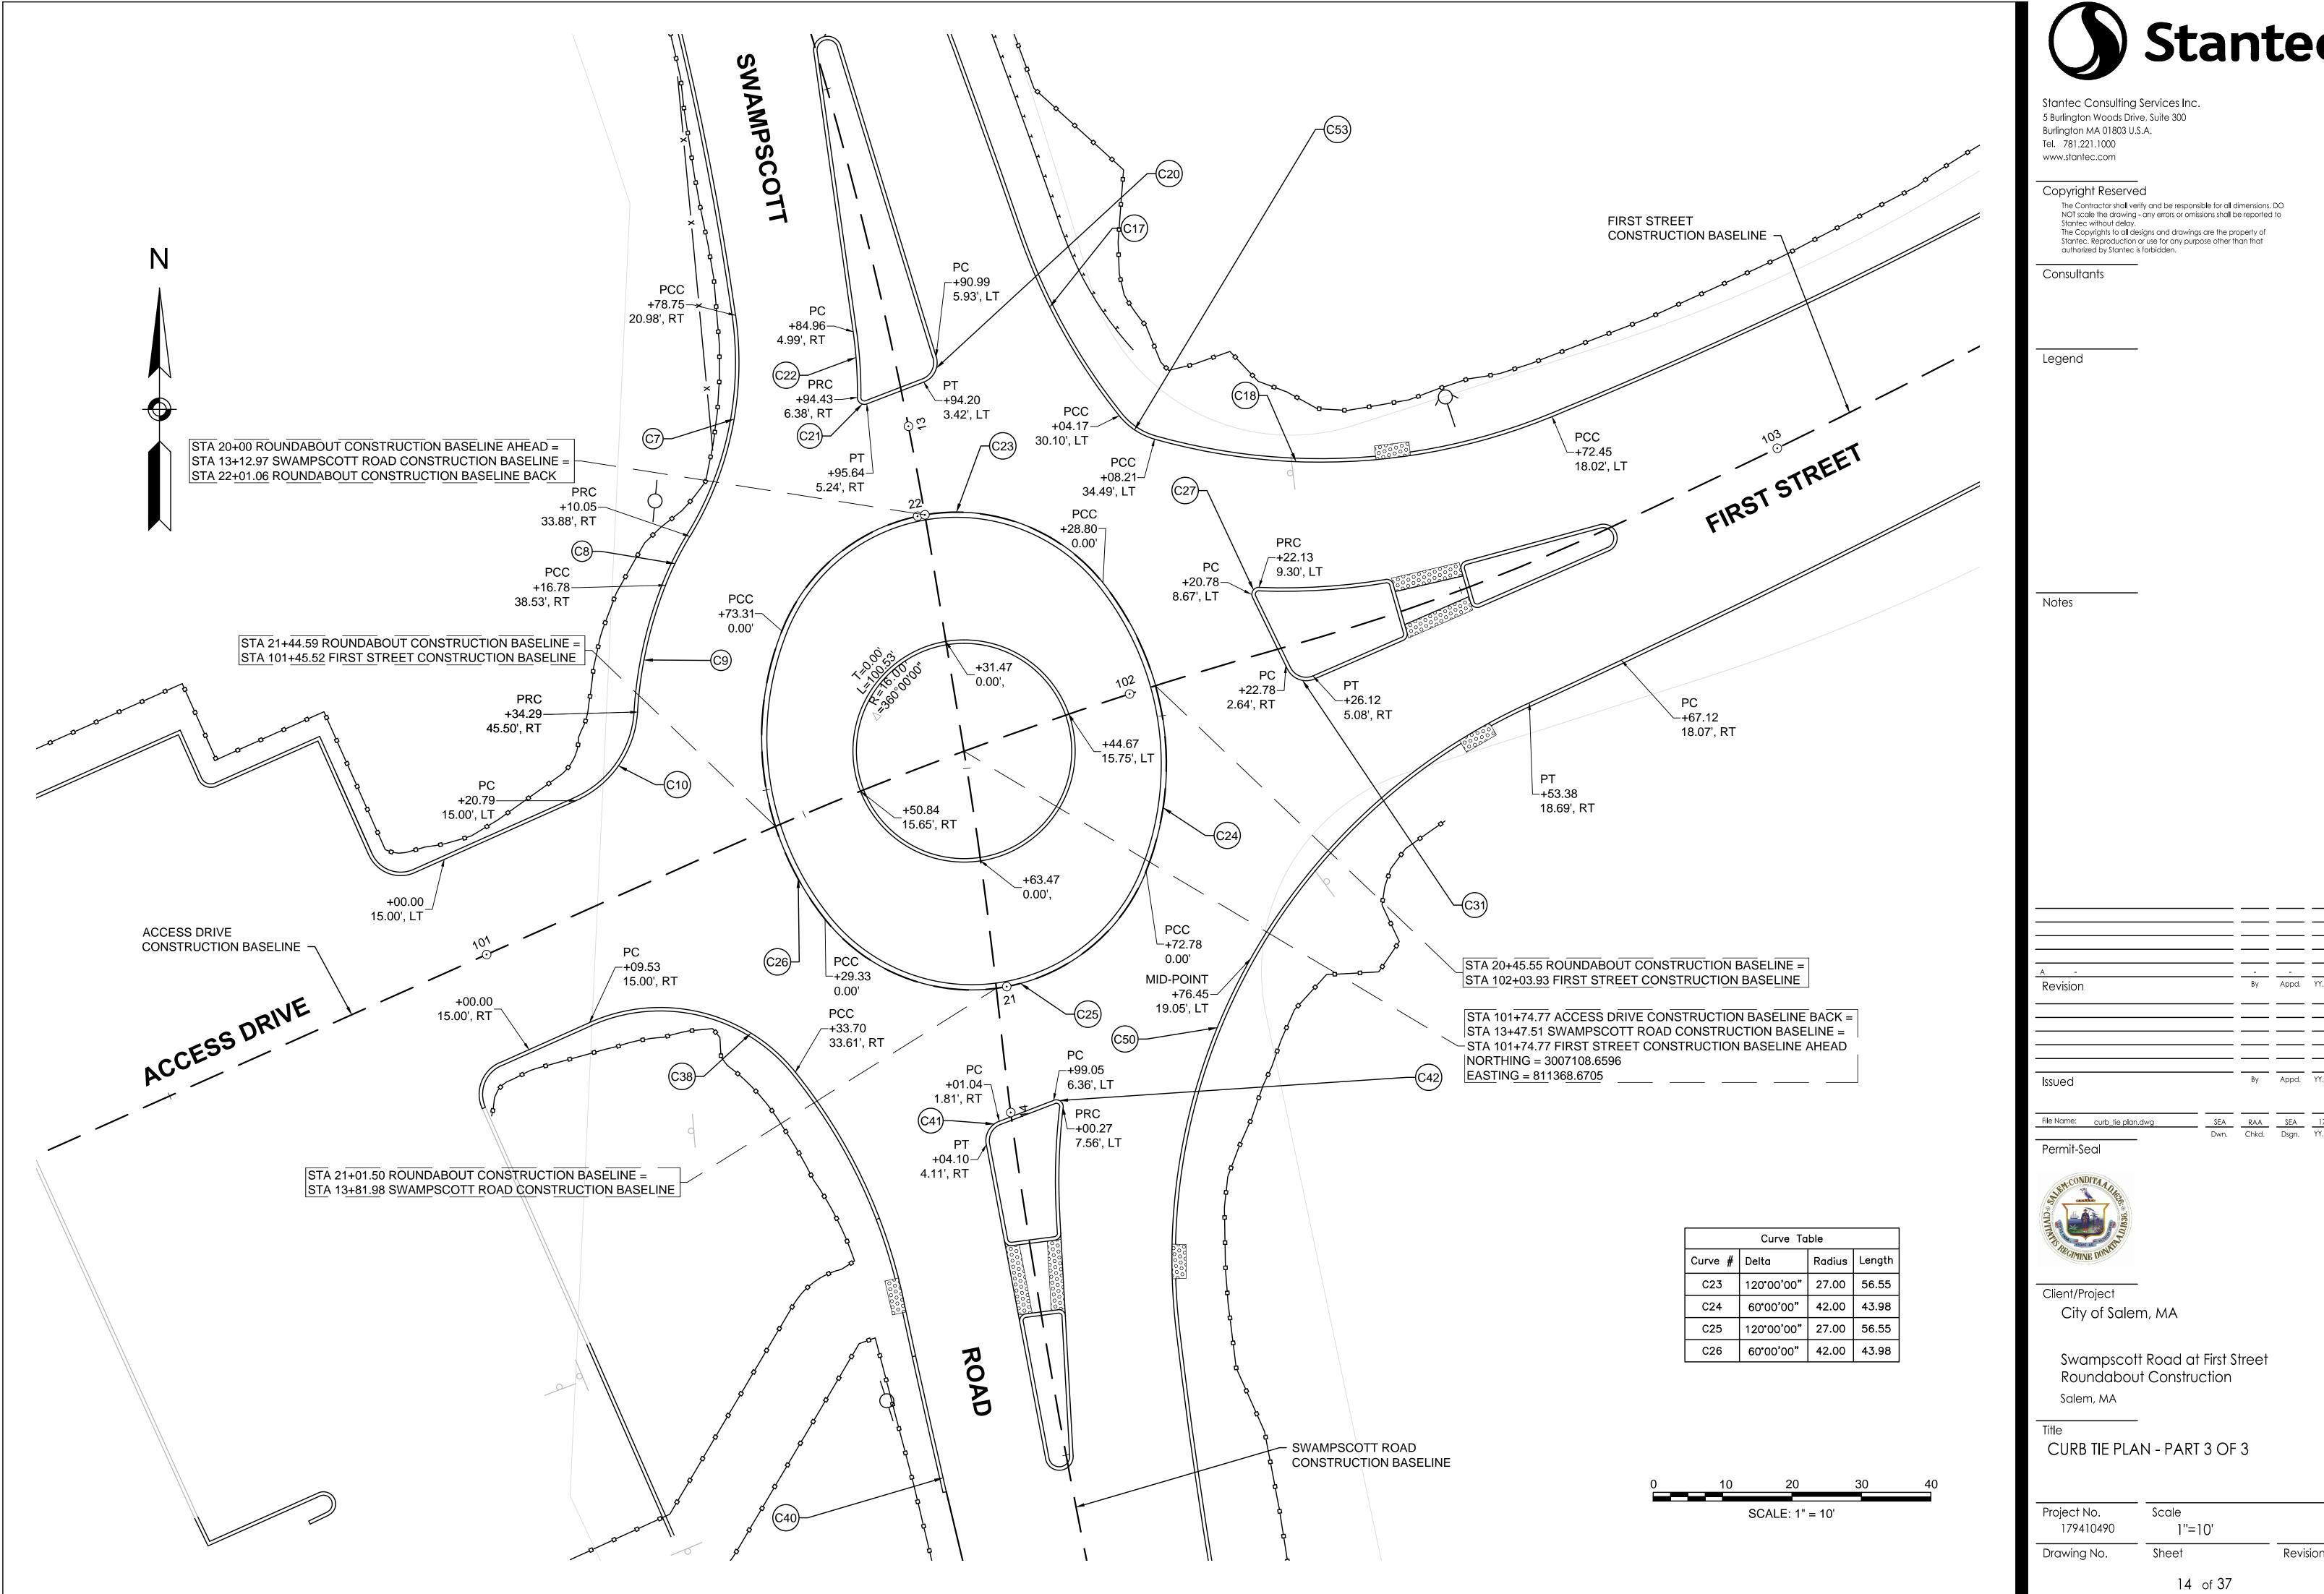



SEARAASEA17.09.06Dwn.Chkd.Dsgn.YY.MM.DD

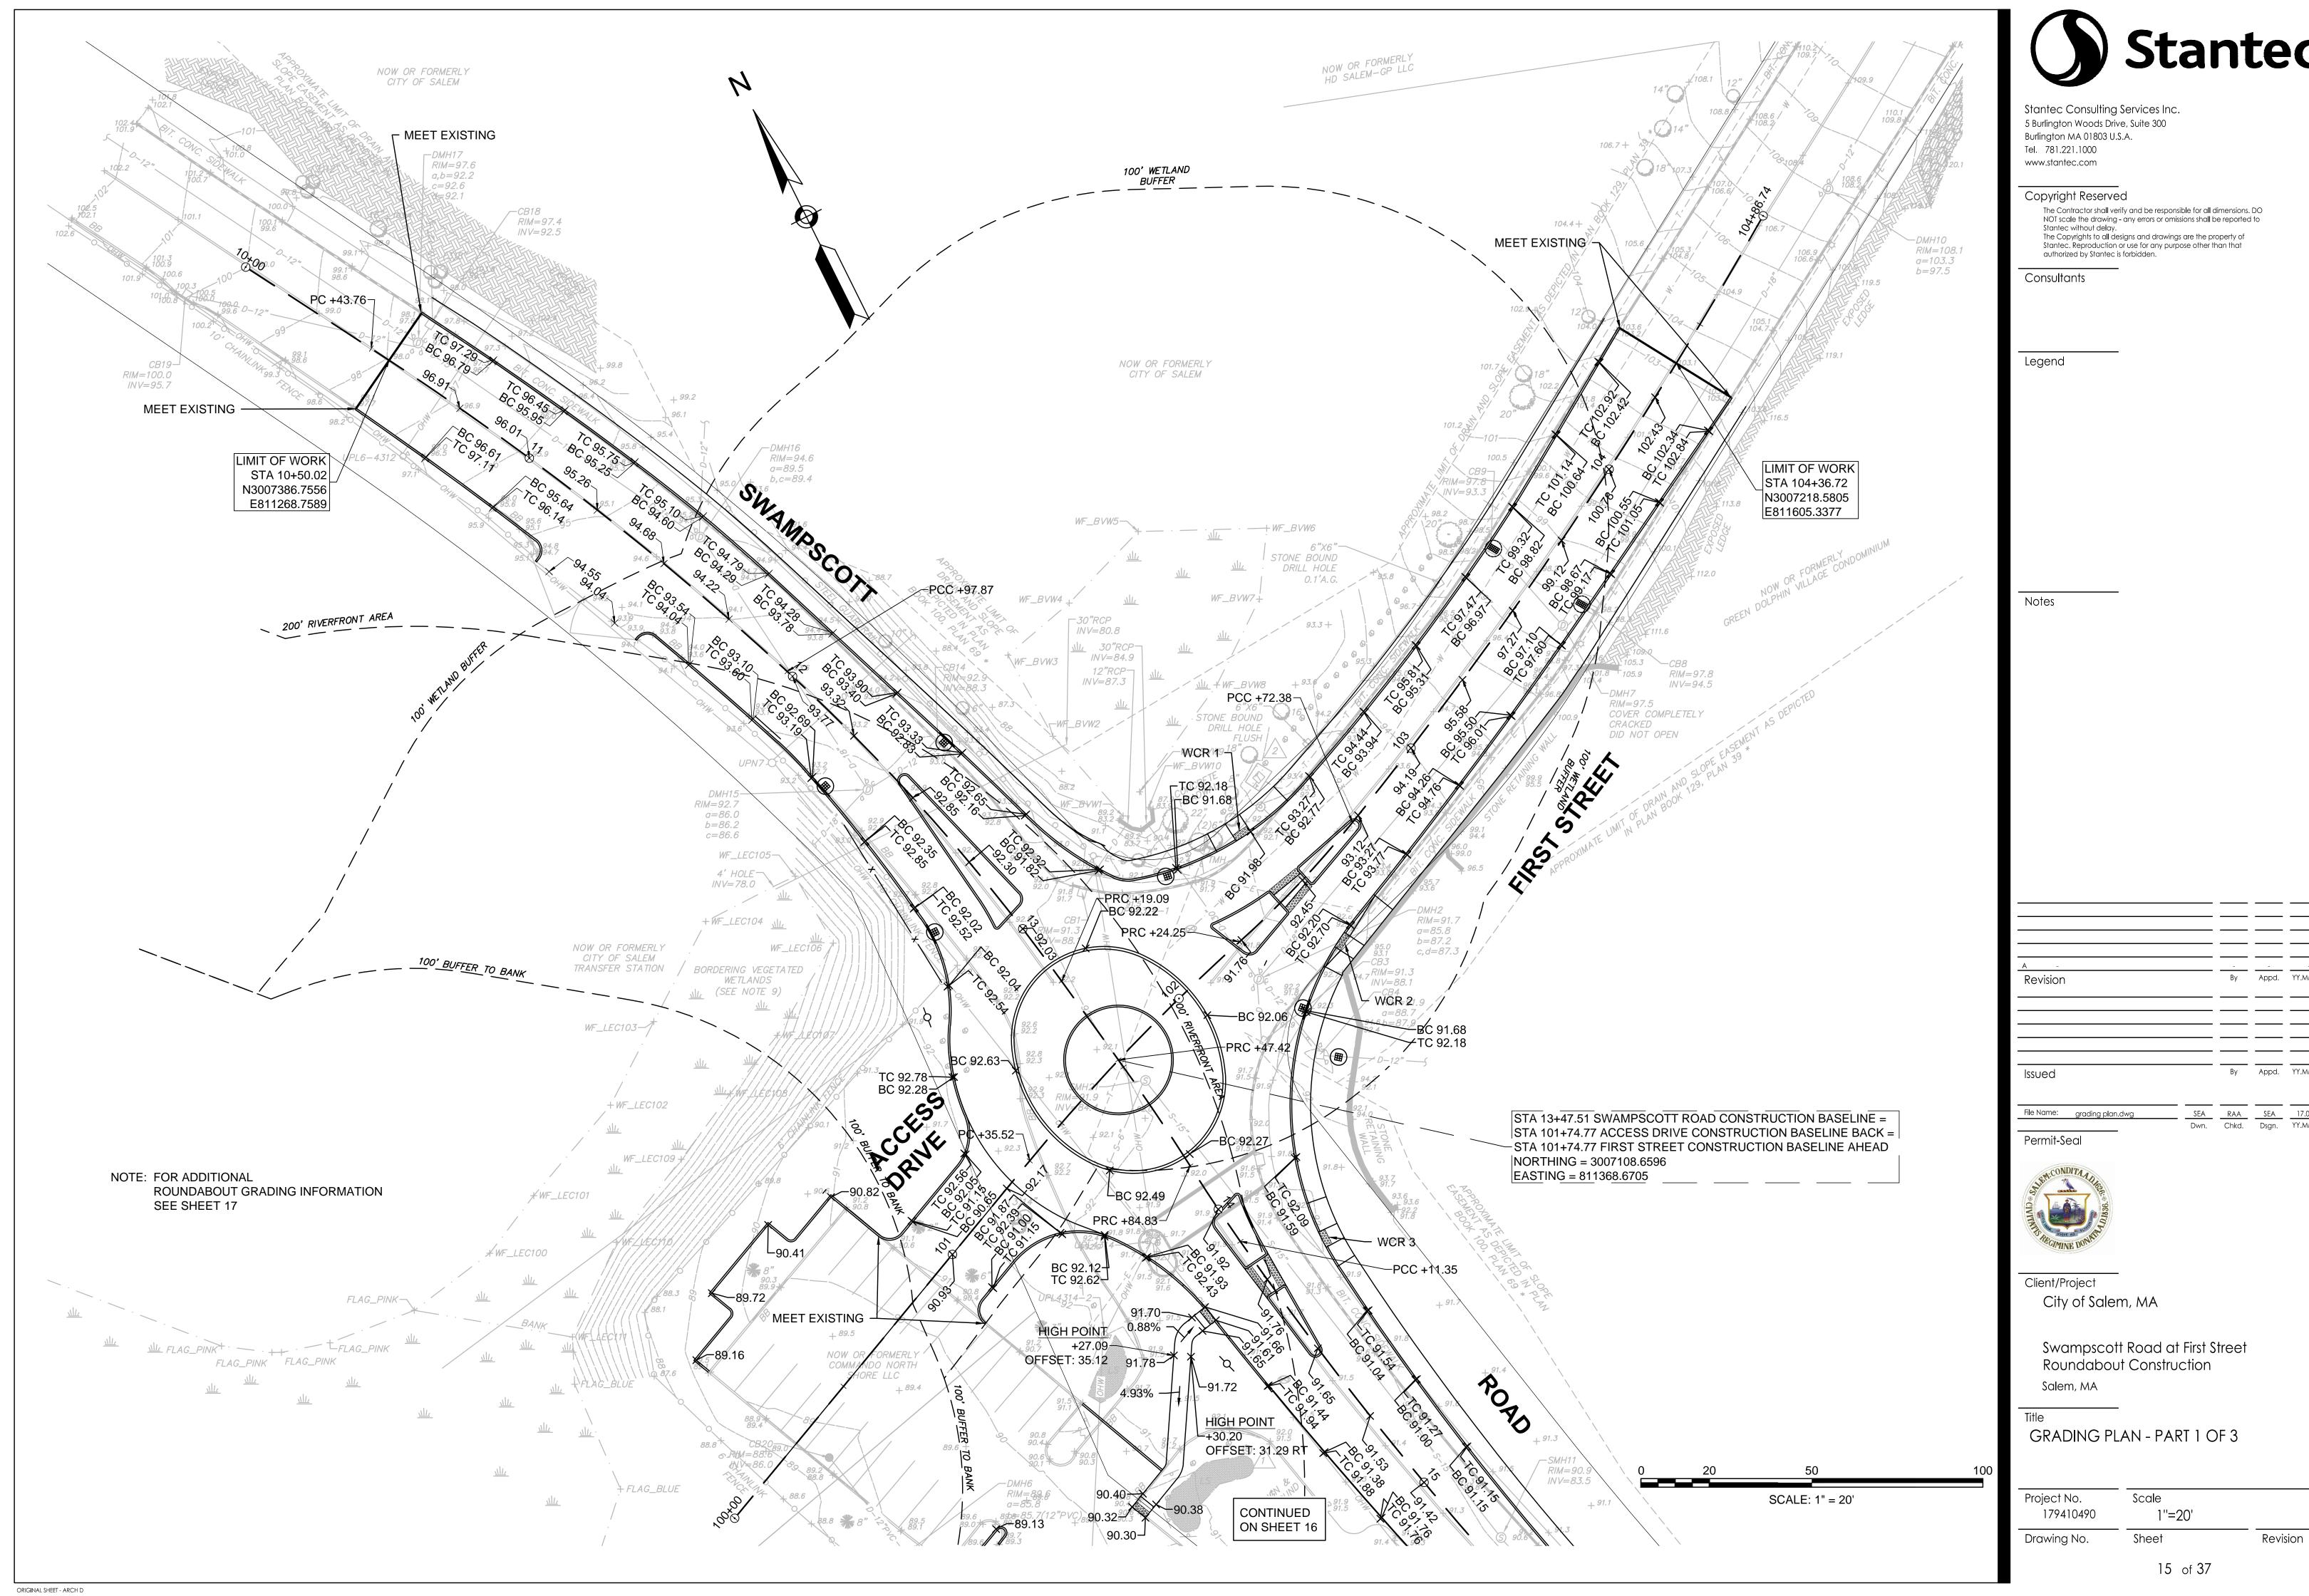

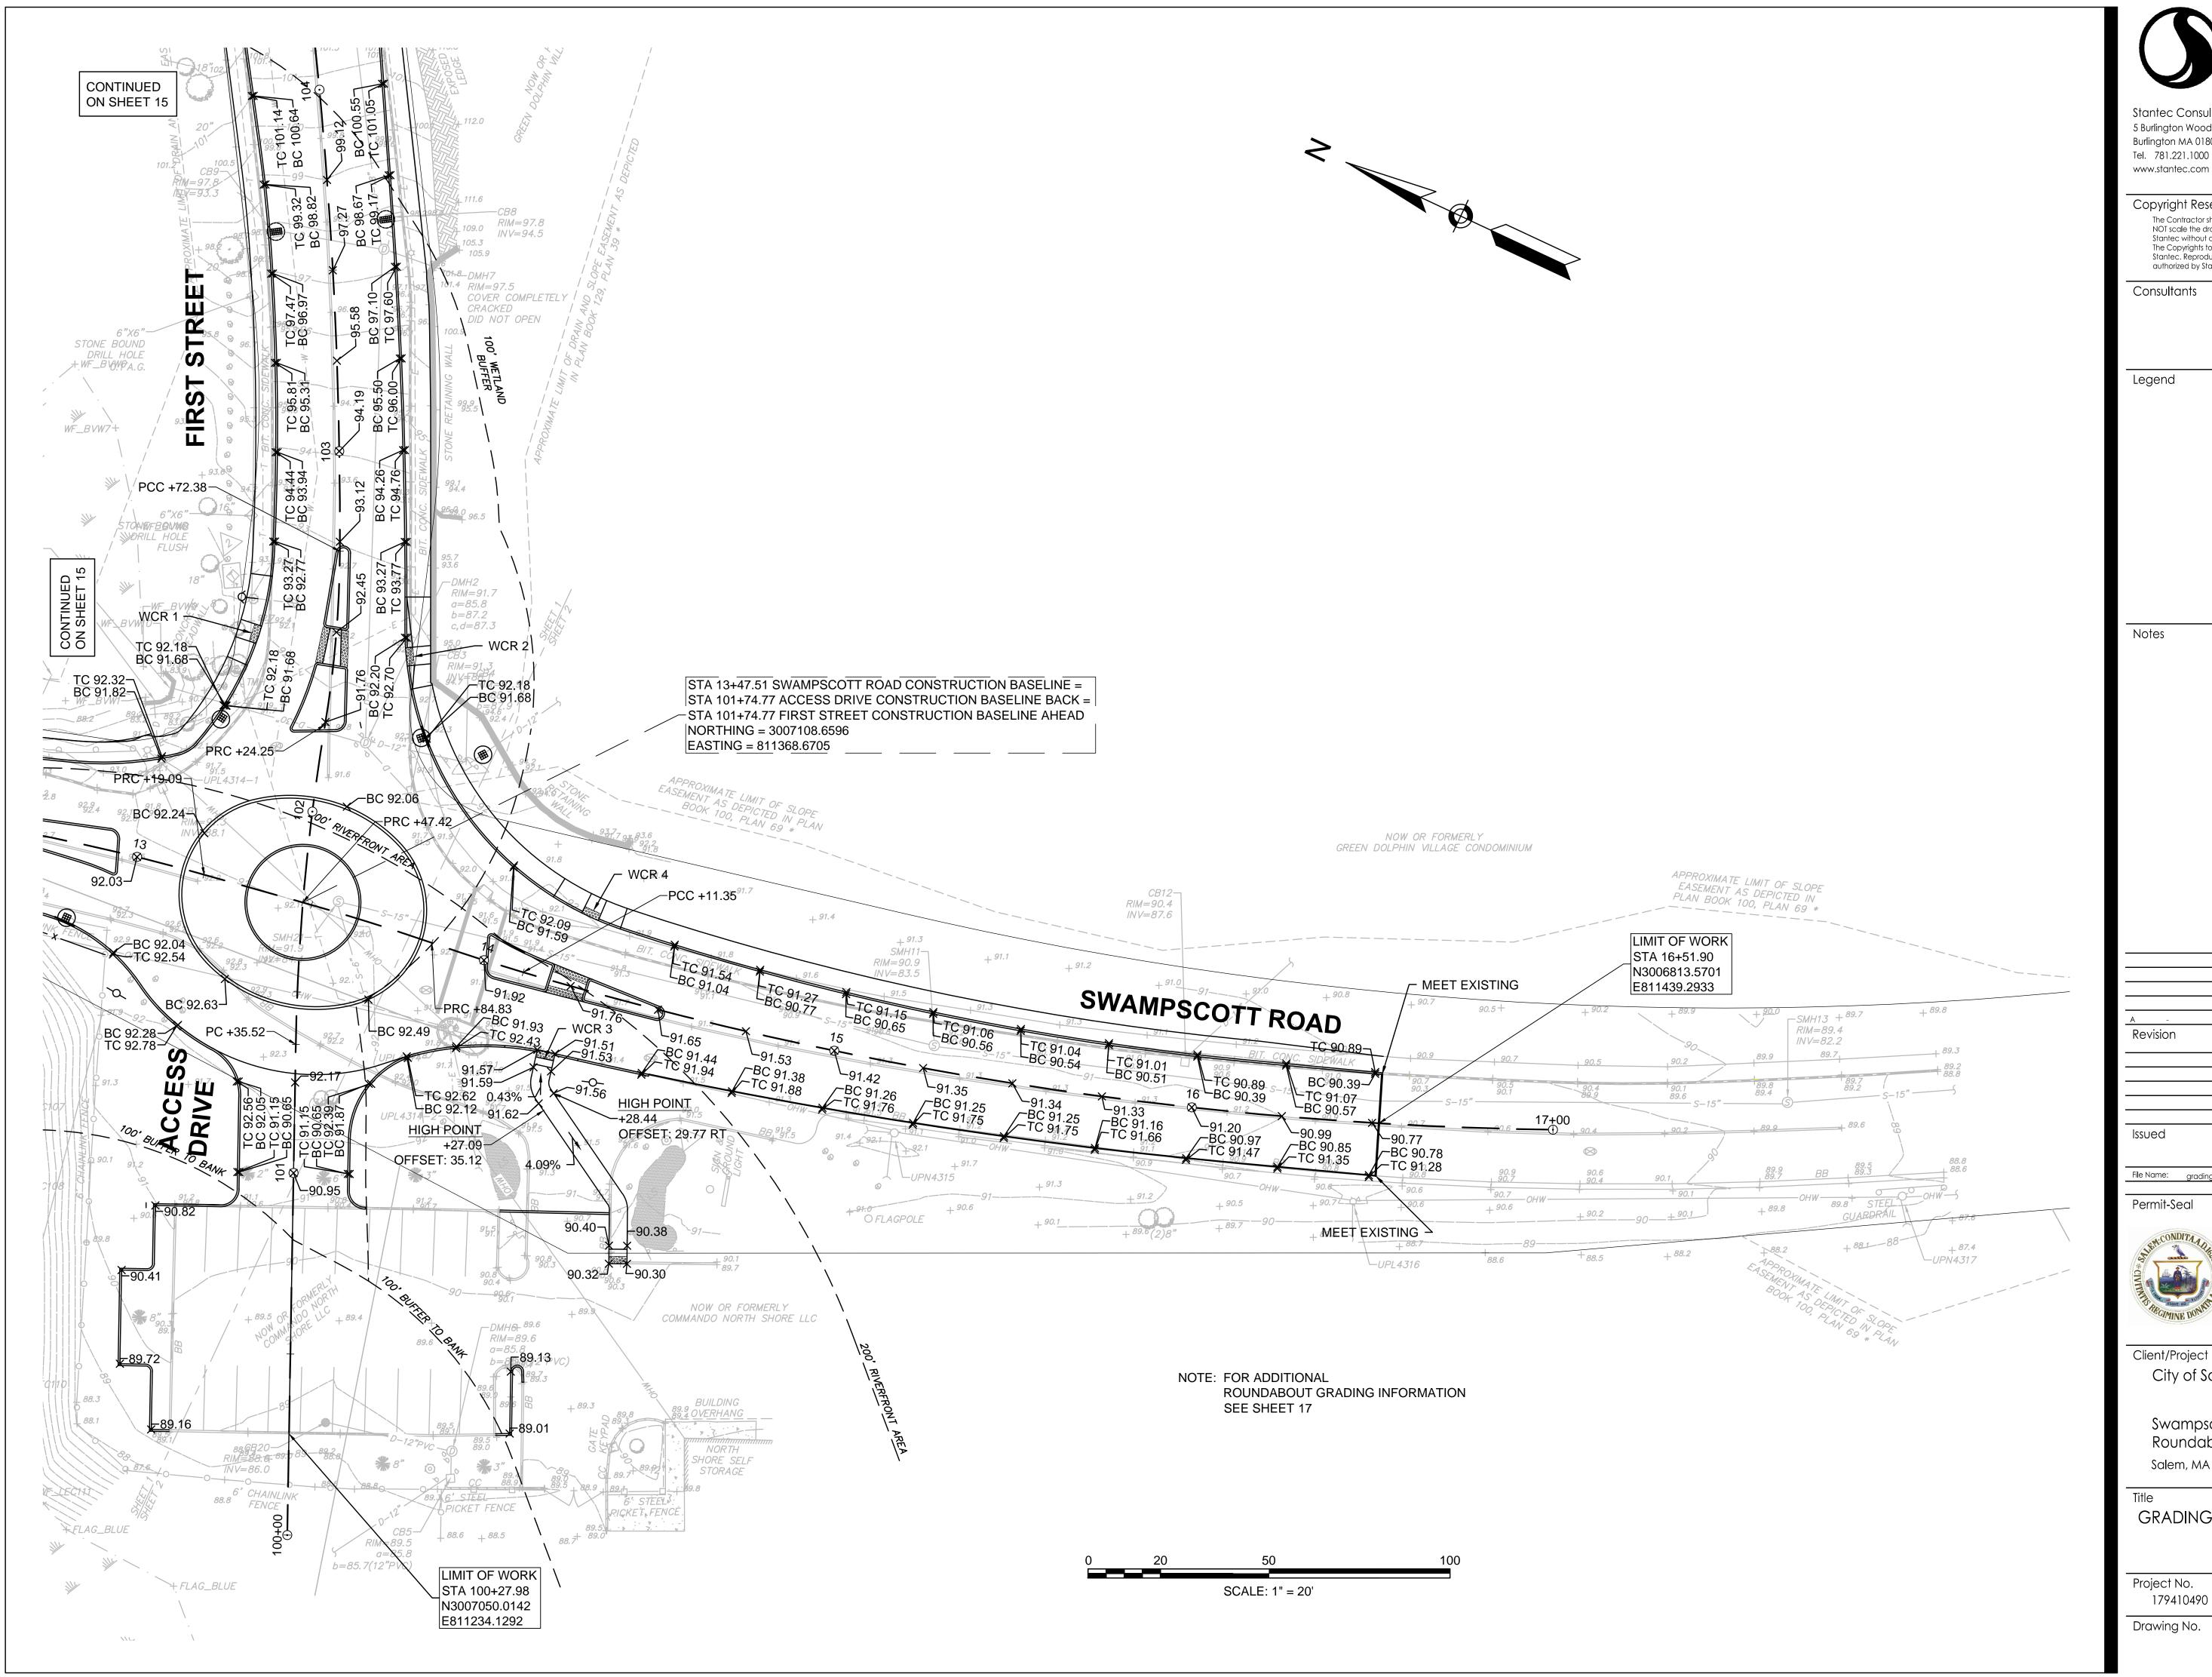



Stantec Consulting Services Inc. 5 Burlington Woods Drive, Suite 300 Burlington MA 01803 U.S.A.

Copyright Reserved

The Contractor shall verify and be responsible for all dimensions. DO NOT scale the drawing - any errors or omissions shall be reported to The Copyrights to all designs and drawings are the property of Stantec. Reproduction or use for any purpose other than that authorized by Stantec is forbidden.

Consultants

SEA RAA SEA 17.09.06
Dwn. Chkd. Dsgn. YY.MM.DD File Name: grading plan.dwg

Permit-Seal




Client/Project City of Salem, MA

> Swampscott Road at First Street Roundabout Construction Salem, MA

GRADING PLAN - PART 2 OF 3

Scale Project No. 1''=20' 179410490 Sheet Revision Drawing No.

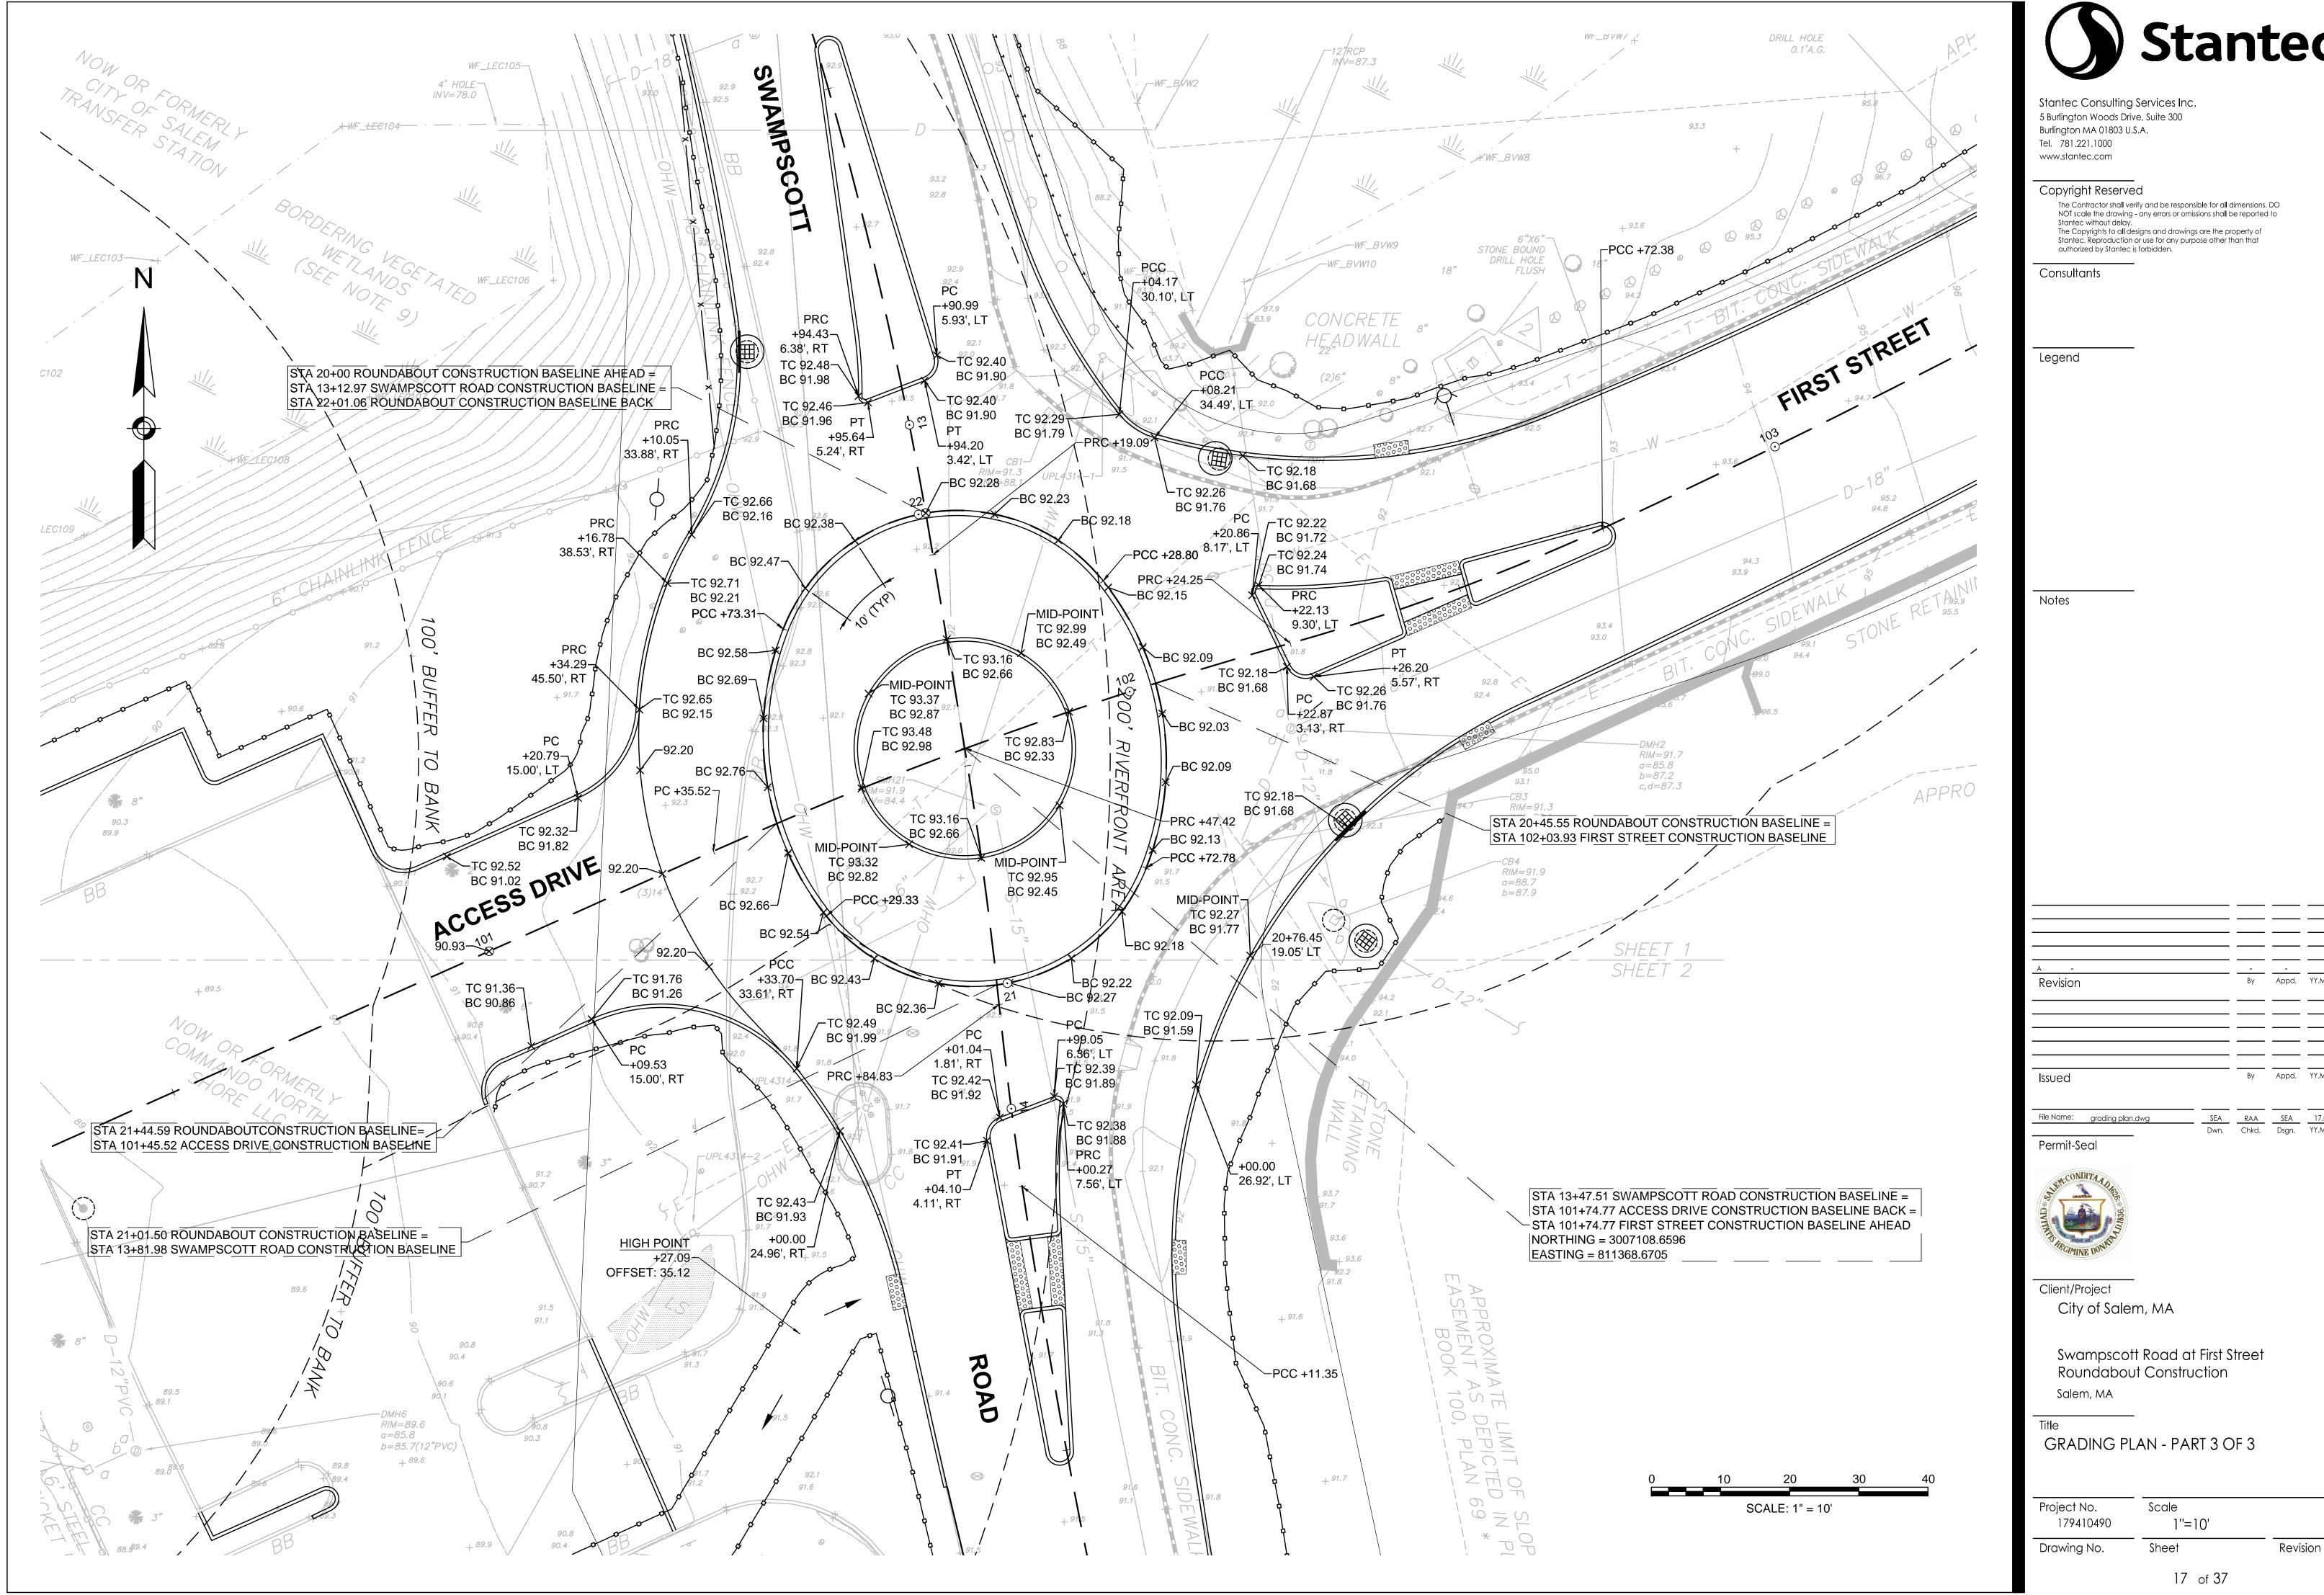



SEARAASEA17.09.06Dwn.Chkd.Dsgn.YY.MM.DD

	DRAINAGE STRUCTURE TABLE											
NAME	STATION	OFFSET	RIM	INV. ELEV. IN	INV. ELEV. OUT	REMARKS						
E-CB-5	13+02.16	20.0 LT	91.88	I=88.27' (P-CBCI-4) I=88.10' (P-CBCI-6)		CIT R&S F&C RET EX INV OUT = 88.1						
P-CB-9	13+81.48	53.7 LT	92.09		I=87.90' (P-CBCI-8)	RET EX INV IN =88.7						
P-CBCI-1	12+29.71	16.3 RT	92.68		I=88.50' ()							
P-CBCI-3	12+44.37	17.6 LT	92.90		I=87.00' ()							
P-CBCI-4	12+84.55	20.8 RT	91.99		I=88.46' (E-CB-5)							
P-CBCI-6	13+12.45	42.6 LT	91.68		I=88.20' (E-CB-5)	ECCENTRIC STRUCTURE TO AVOID EX UTILITIES						
P-CBCI-8	13+65.18	52.9 LT	91.68	I=87.80' (P-CB-9)	I=87.60' ()							
P-DBCBCI-13	103+61.75	13.5 LT	97.91		I=93.30' ()							
P-DBCBCI-14	103+63.21	17.1 RT	97.83		I=94.50' ()							

		PIPE TABLE			
PIPE	PIPE LOCATION	SIZE & TYPE	LENGTH	SLOPE	REMARKS
P-1	P-CBCI-3 TO STA 12+44 TO 12+43	12" REINFORCED CONCRETE	6 LF	0.012	CTE 12" RCP PIPE
P-3	P-CBCI-8 TO STA 13+65 TO 13+52	12" REINFORCED CONCRETE	14 LF	0.006	
P-4	P-DBCBCI-13 TO STA 103+62 TO 103+60	12" REINFORCED CONCRETE	5 LF	0.014	CTE 12" RCP PIPE
P-5	P-DBCBCI-14 TO STA 103+63 TO 103+60	12" REINFORCED CONCRETE	1 LF	0.032	CTE 12" RCP PIPE
P-11	P-CBCI-4 TO E-CB-5 STA 12+85 TO 13+02	12" REINFORCED CONCRETE	40 LF	0.004	CL. V RCP
P-13	P-CBCI-6 TO E-CB-5 STA 13+12 TO 13+02	12" REINFORCED CONCRETE	21 LF	0.004	CL. V RCP
P-19	P-CB-9 TO P-CBCI-8 STA 13+81 TO 13+65	12" REINFORCED CONCRETE	14 LF	0.006	
P-20	P-CBCI-1 TO STA 12+30 TO 12+39	12" REINFORCED CONCRETE	10 LF	0.008	



Stantec Consulting Services Inc. 5 Burlington Woods Drive, Suite 300 Burlington MA 01803 U.S.A. Tel. 781.221.1000 www.stantec.com

Copyright Reserved

The Contractor shall verify and be responsible for all dimensions. DO NOT scale the drawing - any errors or omissions shall be reported to Stantec without delay.

The Copyrights to all designs and drawings are the property of Stantec. Reproduction or use for any purpose other than that authorized by Stantec is forbidden.

Consultants

Legend

Α -				-
Revision		Ву	Appd.	YY.MM.DI
Issued		Ву	Appd.	YY.MM.DI
File Name: drain schedules.dwg	SEA	RAA	SEA	17.09.06
	Dwn.	Chkd.	Dsgn.	YY.MM.DI

Permit-Seal



Client/Project
City of Salem, MA


Swampscott Road at First Street Roundabout Construction Salem, MA


Title

SCALE: 1" = 20'

DRAINAGE PIPE & STRUCTURE SCHEDULE

Project No.	Scale	
179410490	NTS	
Drawing No.	Sheet	Revisio

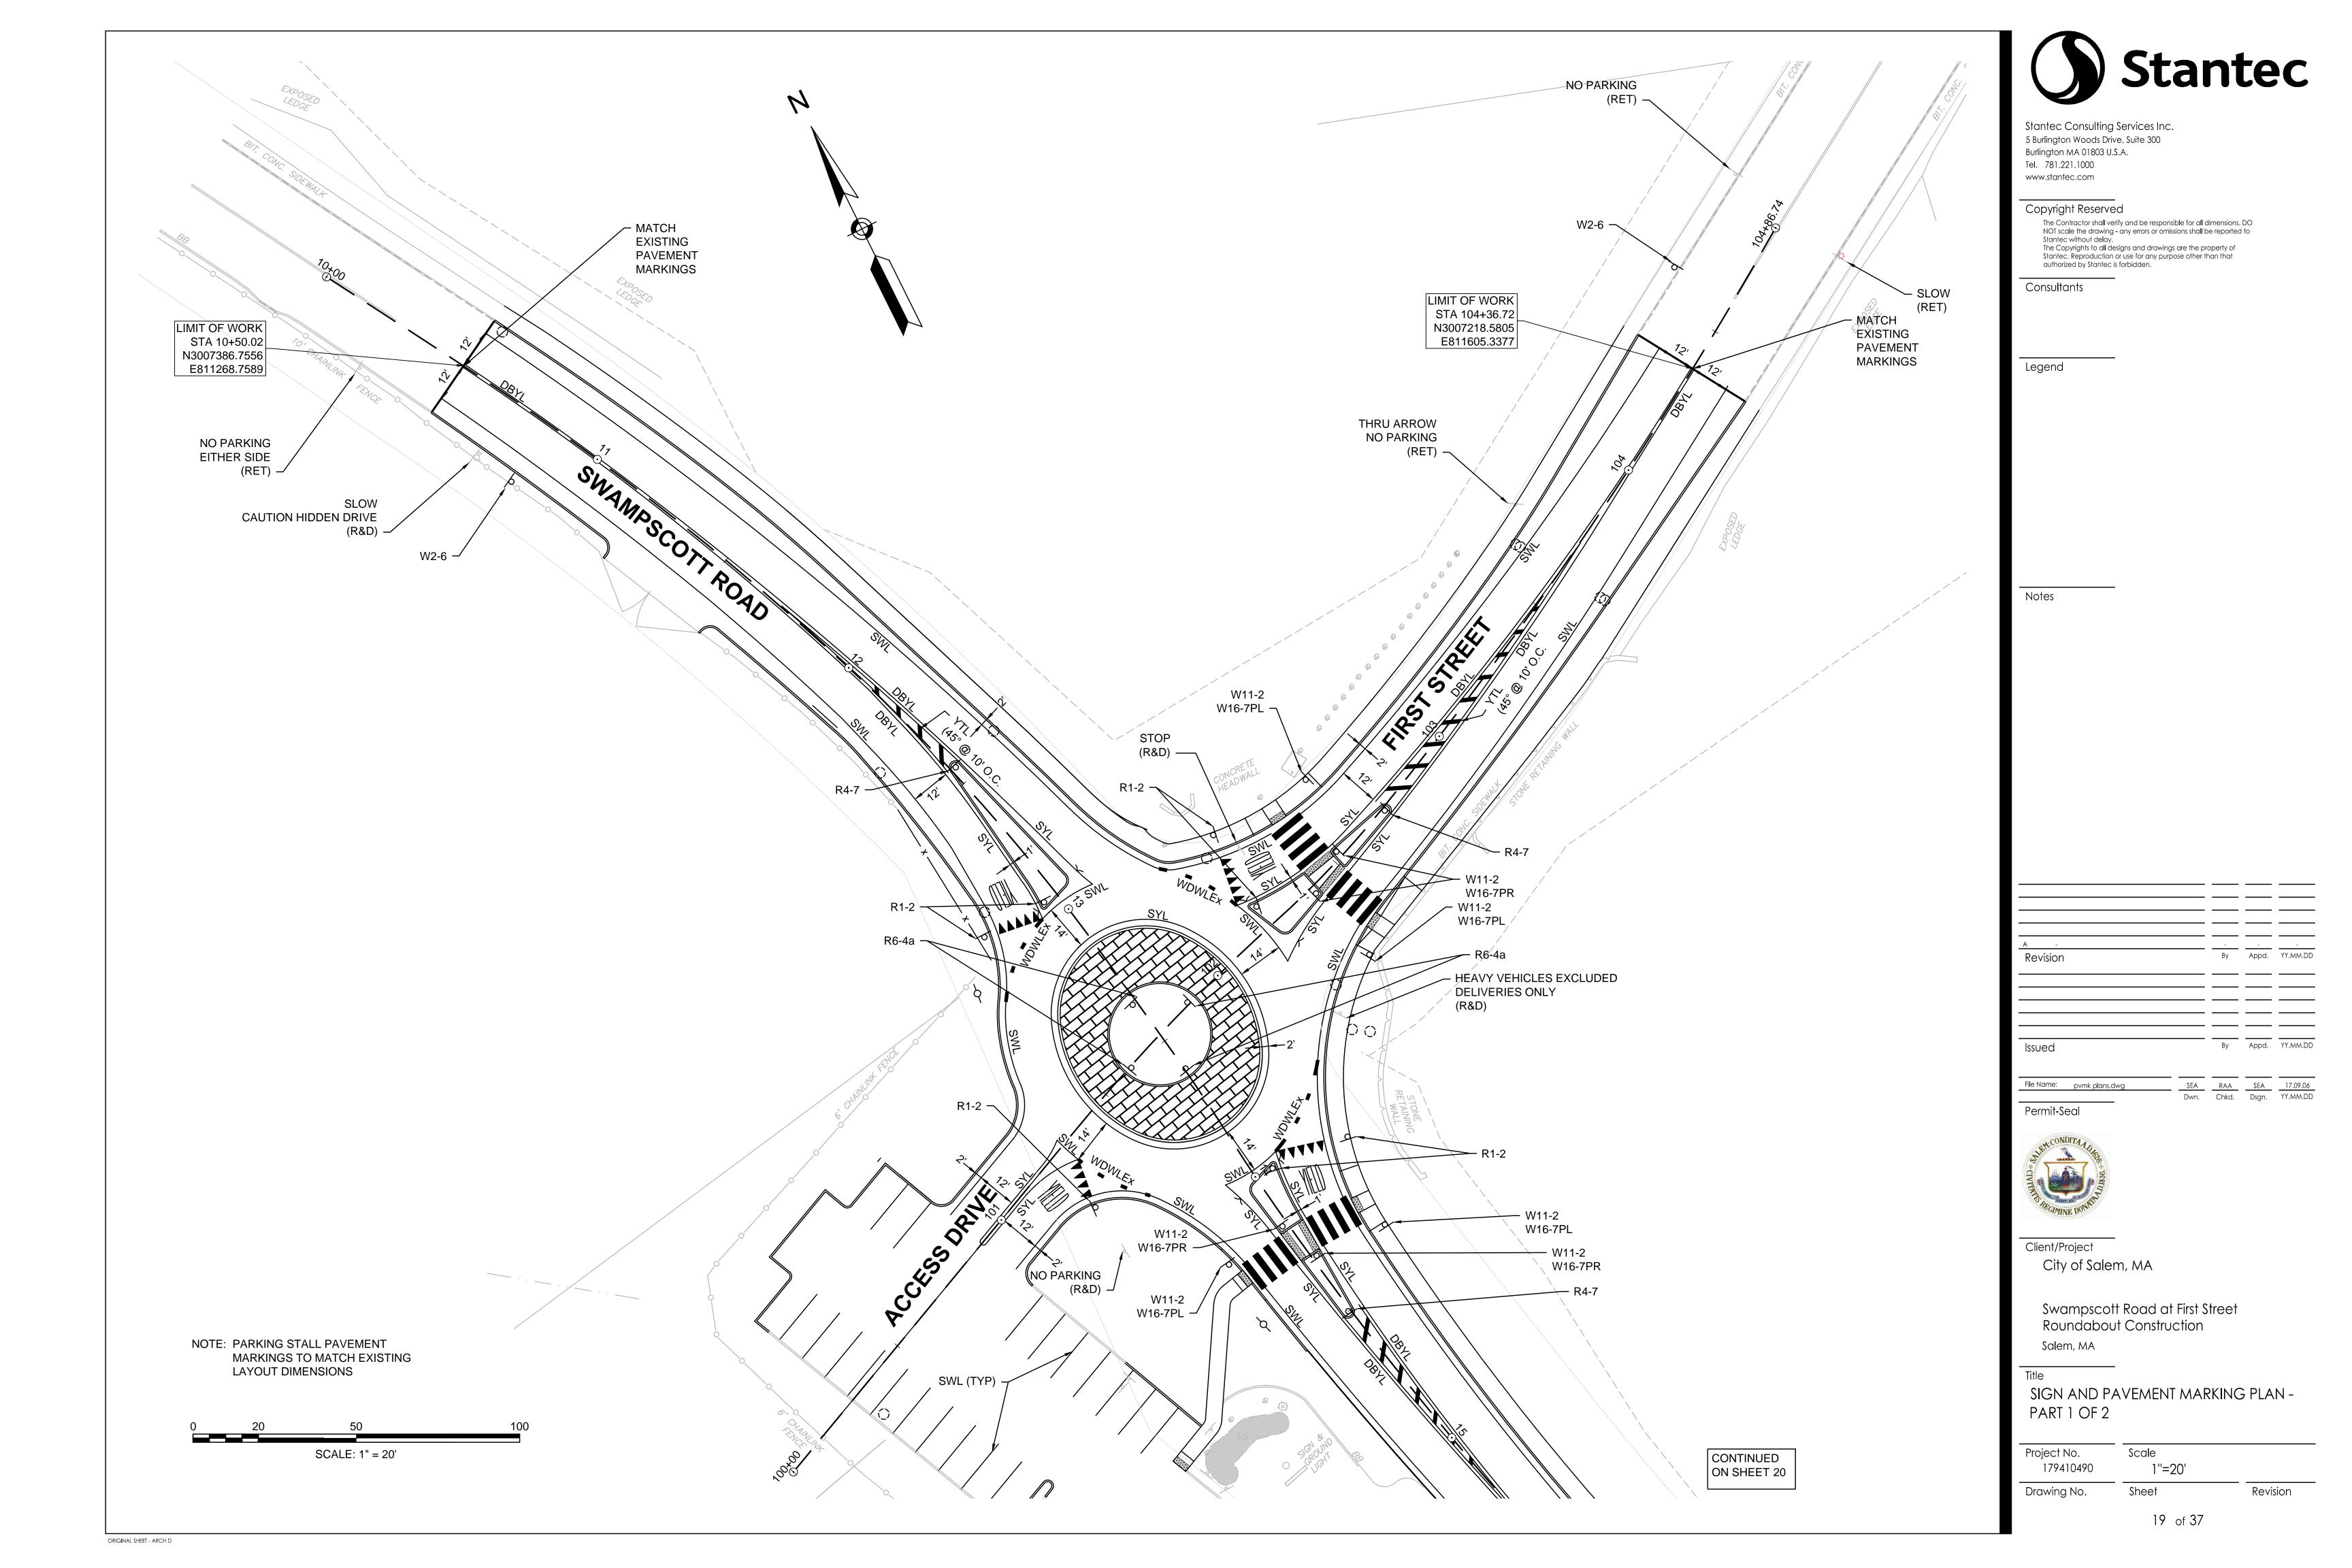

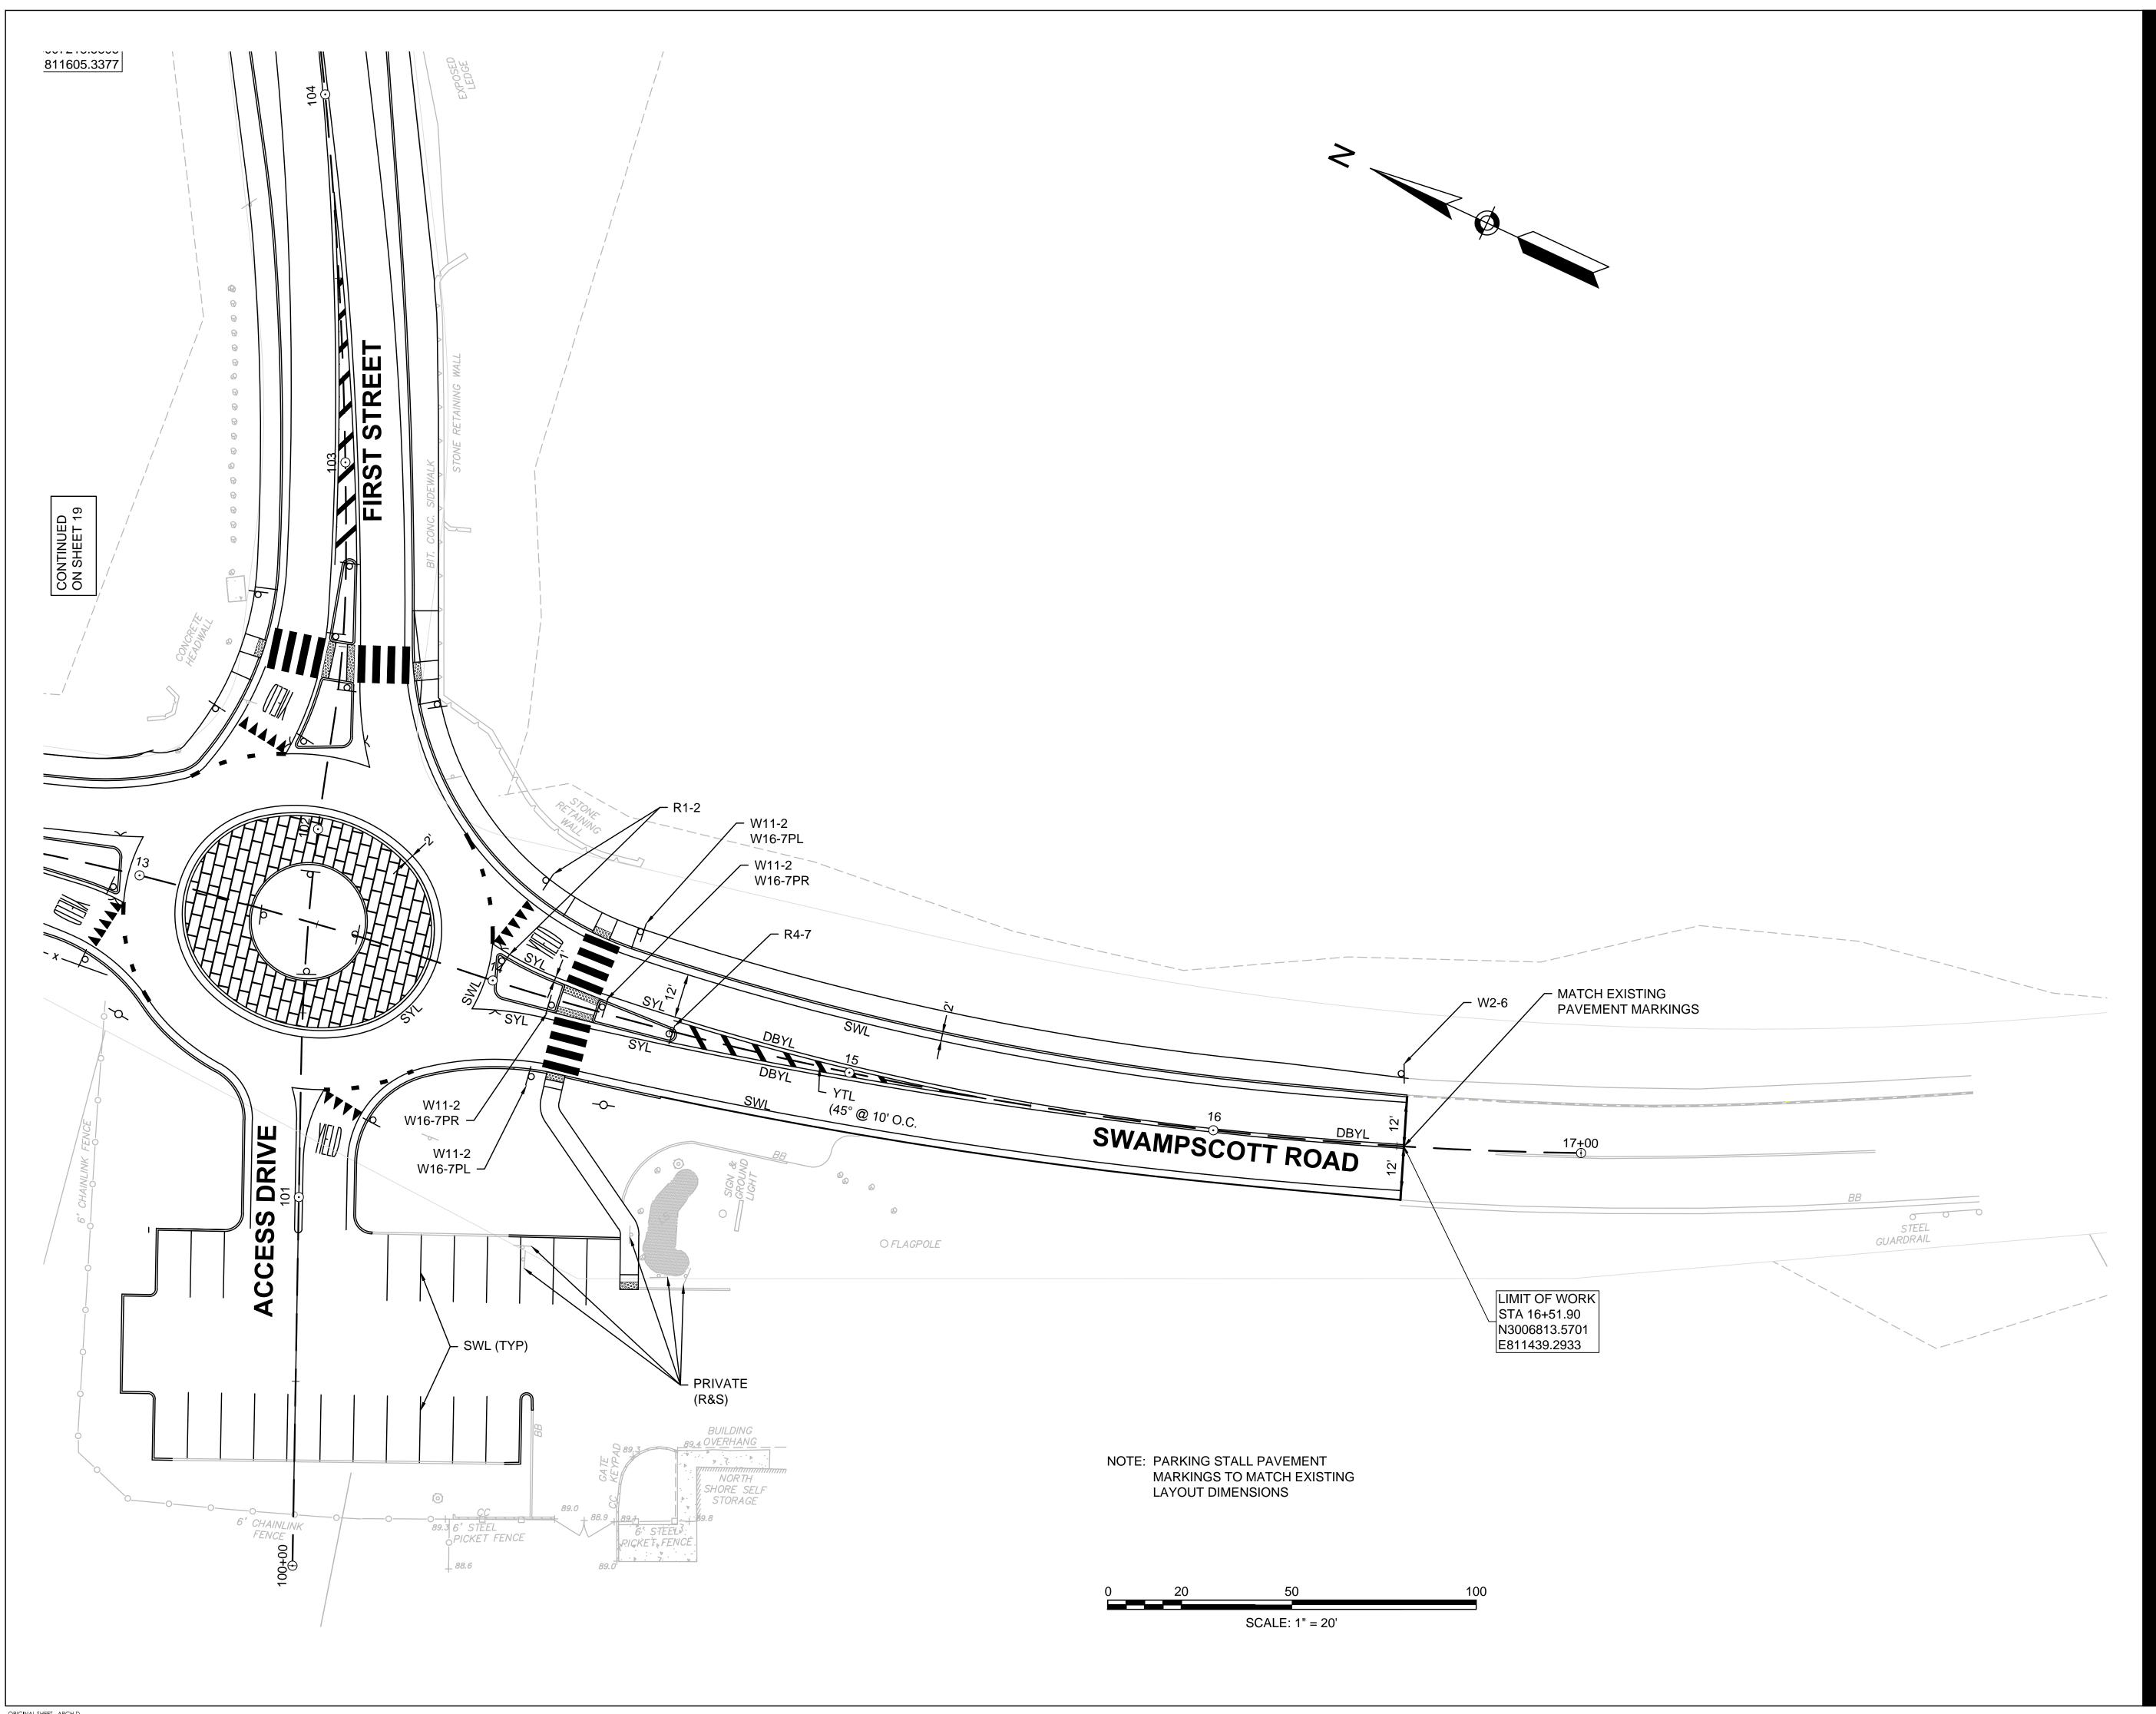



Stantec Consulting Services Inc. 5 Burlington Woods Drive, Suite 300 Burlington MA 01803 U.S.A. Tel. 781.221.1000

Copyright Reserved

www.stantec.com

The Contractor shall verify and be responsible for all dimensions. DO NOT scale the drawing - any errors or omissions shall be reported to The Copyrights to all designs and drawings are the property of Stantec. Reproduction or use for any purpose other than that authorized by Stantec is forbidden.

Consultants

File Name: pvmk plans.dwg

Permit-Seal



Client/Project City of Salem, MA

Swampscott Road at First Street Roundabout Construction Salem, MA

SIGN AND PAVEMENT MARKING PLAN - PART 2 OF 2

Project No. Scale 179410490 Drawing No.

1''=20' Revision Sheet

20 of 37

TRAFFIC SIGN SUMMARY

IDENTIFI-	SIZE O	F SIGN		TE	EXT DI	MENSI	ONS (I	INCHE	S)	NUMBER OF		COLOR		POST SIZE AND	UNIT	AREA IN
CATION NUMBER	WIDTH	HEIGHT	TEXT		TER GHT	VERT SPAC		ARR RTE.		SIGNS REQUIRED	BACK- GROUND	LEGEND	BORDER	NUMBER REQUIRED	AREA (S.F.)	SQUARE FEET
R1-2	36" X 36	6" X 36"	YIELD		SEE M	UTCD	STANI	DARDS	S	7	WHITE	RED	RED	1-P5 7	3.90	27.30
R4-7	24"	30"	7							3	WHITE	BLACK	BLACK	1-P5 3	5.00	15.00
R6-4a	48"	24"								4	WHITE	BLACK		1-P5 4	8.00	32.00
W2-6	30"	30"								3	YELLOW	BLACK	BLACK	1-P5 3	9.00	27.00
W11-2	30"	30"								8	YELLOW	BLACK	BLACK	1-P5 8	6.25	50.00
W16-7PL	24"	12"								4	YELLOW	BLACK	BLACK	4 MOUNT WITH OTHER	2.00	8.00
W16-7PR	24"	12"					ı	,		4	YELLOW	BLACK	BLACK	4 MOUNT WITH OTHER	2.00	8.00

NOTES:

- 1. COLOR F.Y.G. = FLUORESCENT YELLOW-GREEN
- 2. P.B.S. = PRINTED BOTH SIDES



Stantec Consulting Services Inc. 5 Burlington Woods Drive, Suite 300 Burlington MA 01803 U.S.A. Tel. 781.221.1000 www.stantec.com

Copyright Reserved

The Contractor shall verify and be responsible for all dimensions. DO NOT scale the drawing - any errors or omissions shall be reported to Stantec without delay.

The Copyrights to all designs and drawings are the property of Stantec. Reproduction or use for any purpose other than that authorized by Stantec is forbidden.

Consultants

Leaend

Note

Permit-Seal



Client/Project
City of Salem, MA

Swampscott Road at First Street Roundabout Construction
Salem, MA

Title
TRAFFIC SIGN SUMMARY

 Project No.
 Scale


 179410490
 1"=20"

 Drawing No.
 Sheet
 Revision

21 of 37

ORIGINAL SHEET - ARCH D

311661

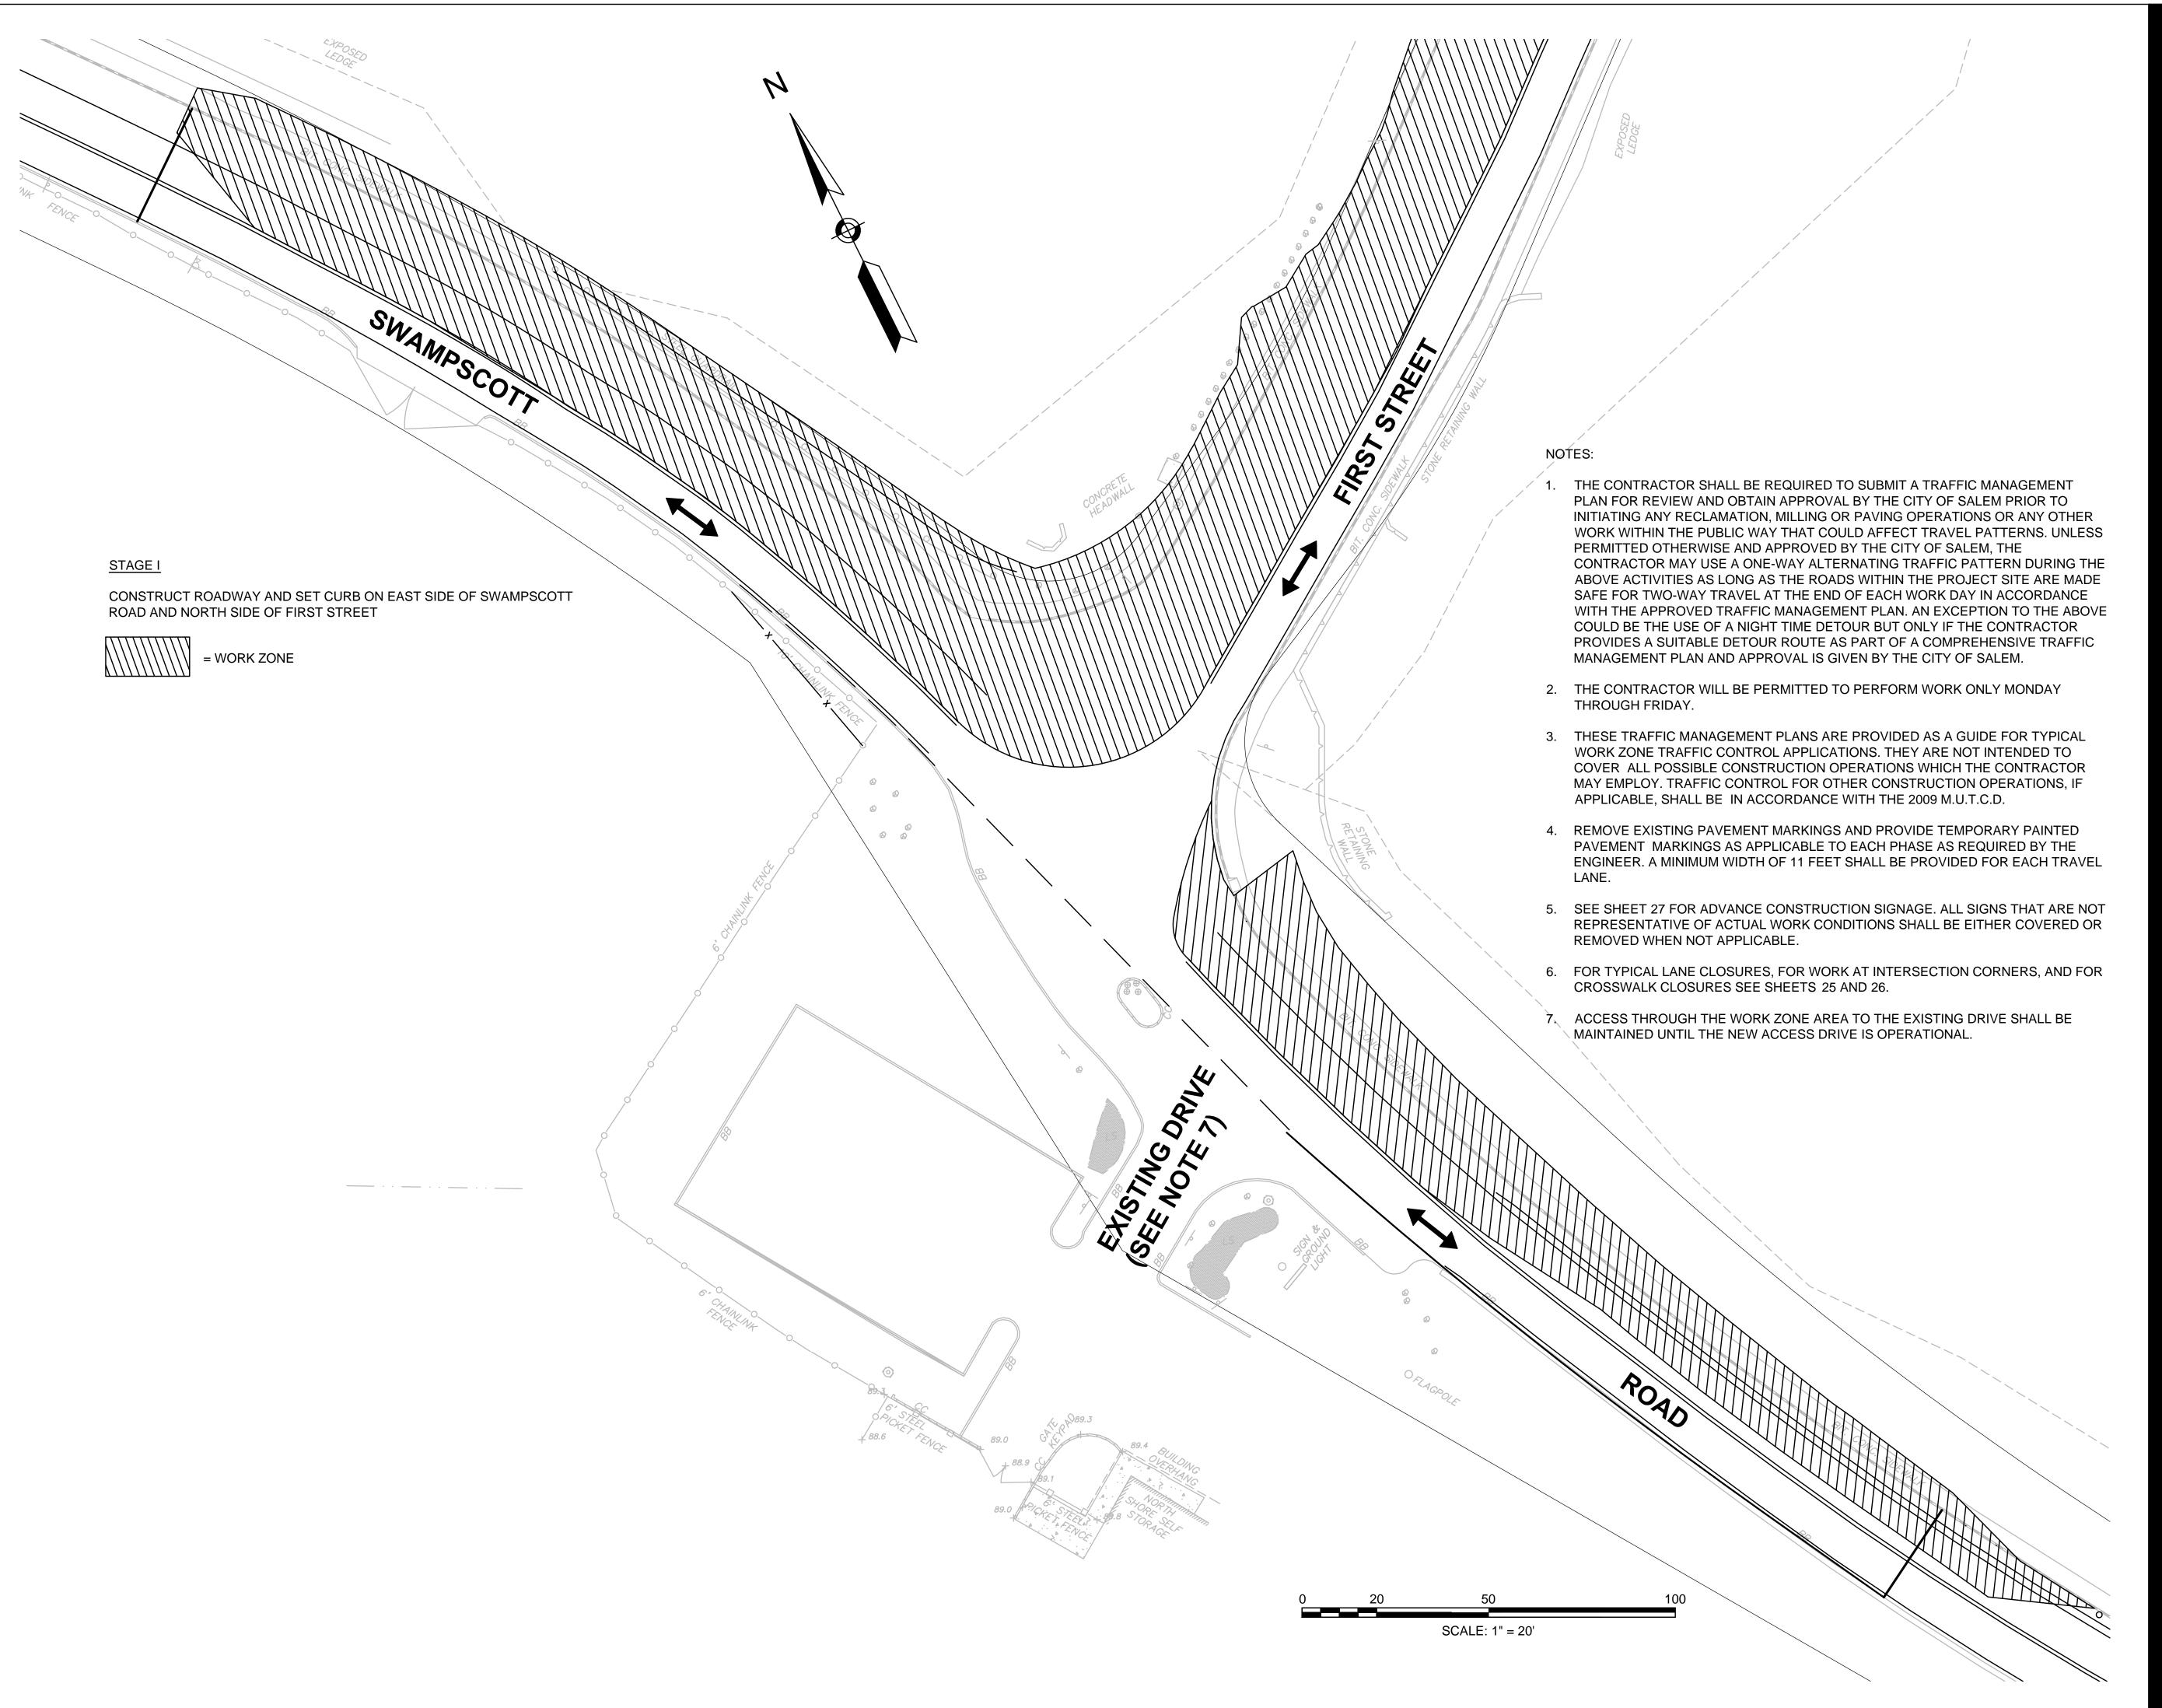



Stantec Consulting Services Inc. 5 Burlington Woods Drive, Suite 300

Burlington MA 01803 U.S.A.
Tel. 781.221.1000
www.stantec.com

Copyright Reserved

The Contractor shall verify and be responsible for all dimensions. DO NOT scale the drawing - any errors or omissions shall be reported to Stantec without delay.

The Copyrights to all designs and drawings are the property of Stantec. Reproduction or use for any purpose other than that authorized by Stantec is forbidden.

Consultants

Legend

Notes

M:CONDITALA



Client/Project
City of Salem, MA

Swampscott Road at First Street Roundabout Construction
Salem, MA


Salem, MA

TEMPORARY TRAFFIC CONTROL PLANS -STAGE 1

Project No.
179410490

Drawing No.

Scale 1''=20' Sheet

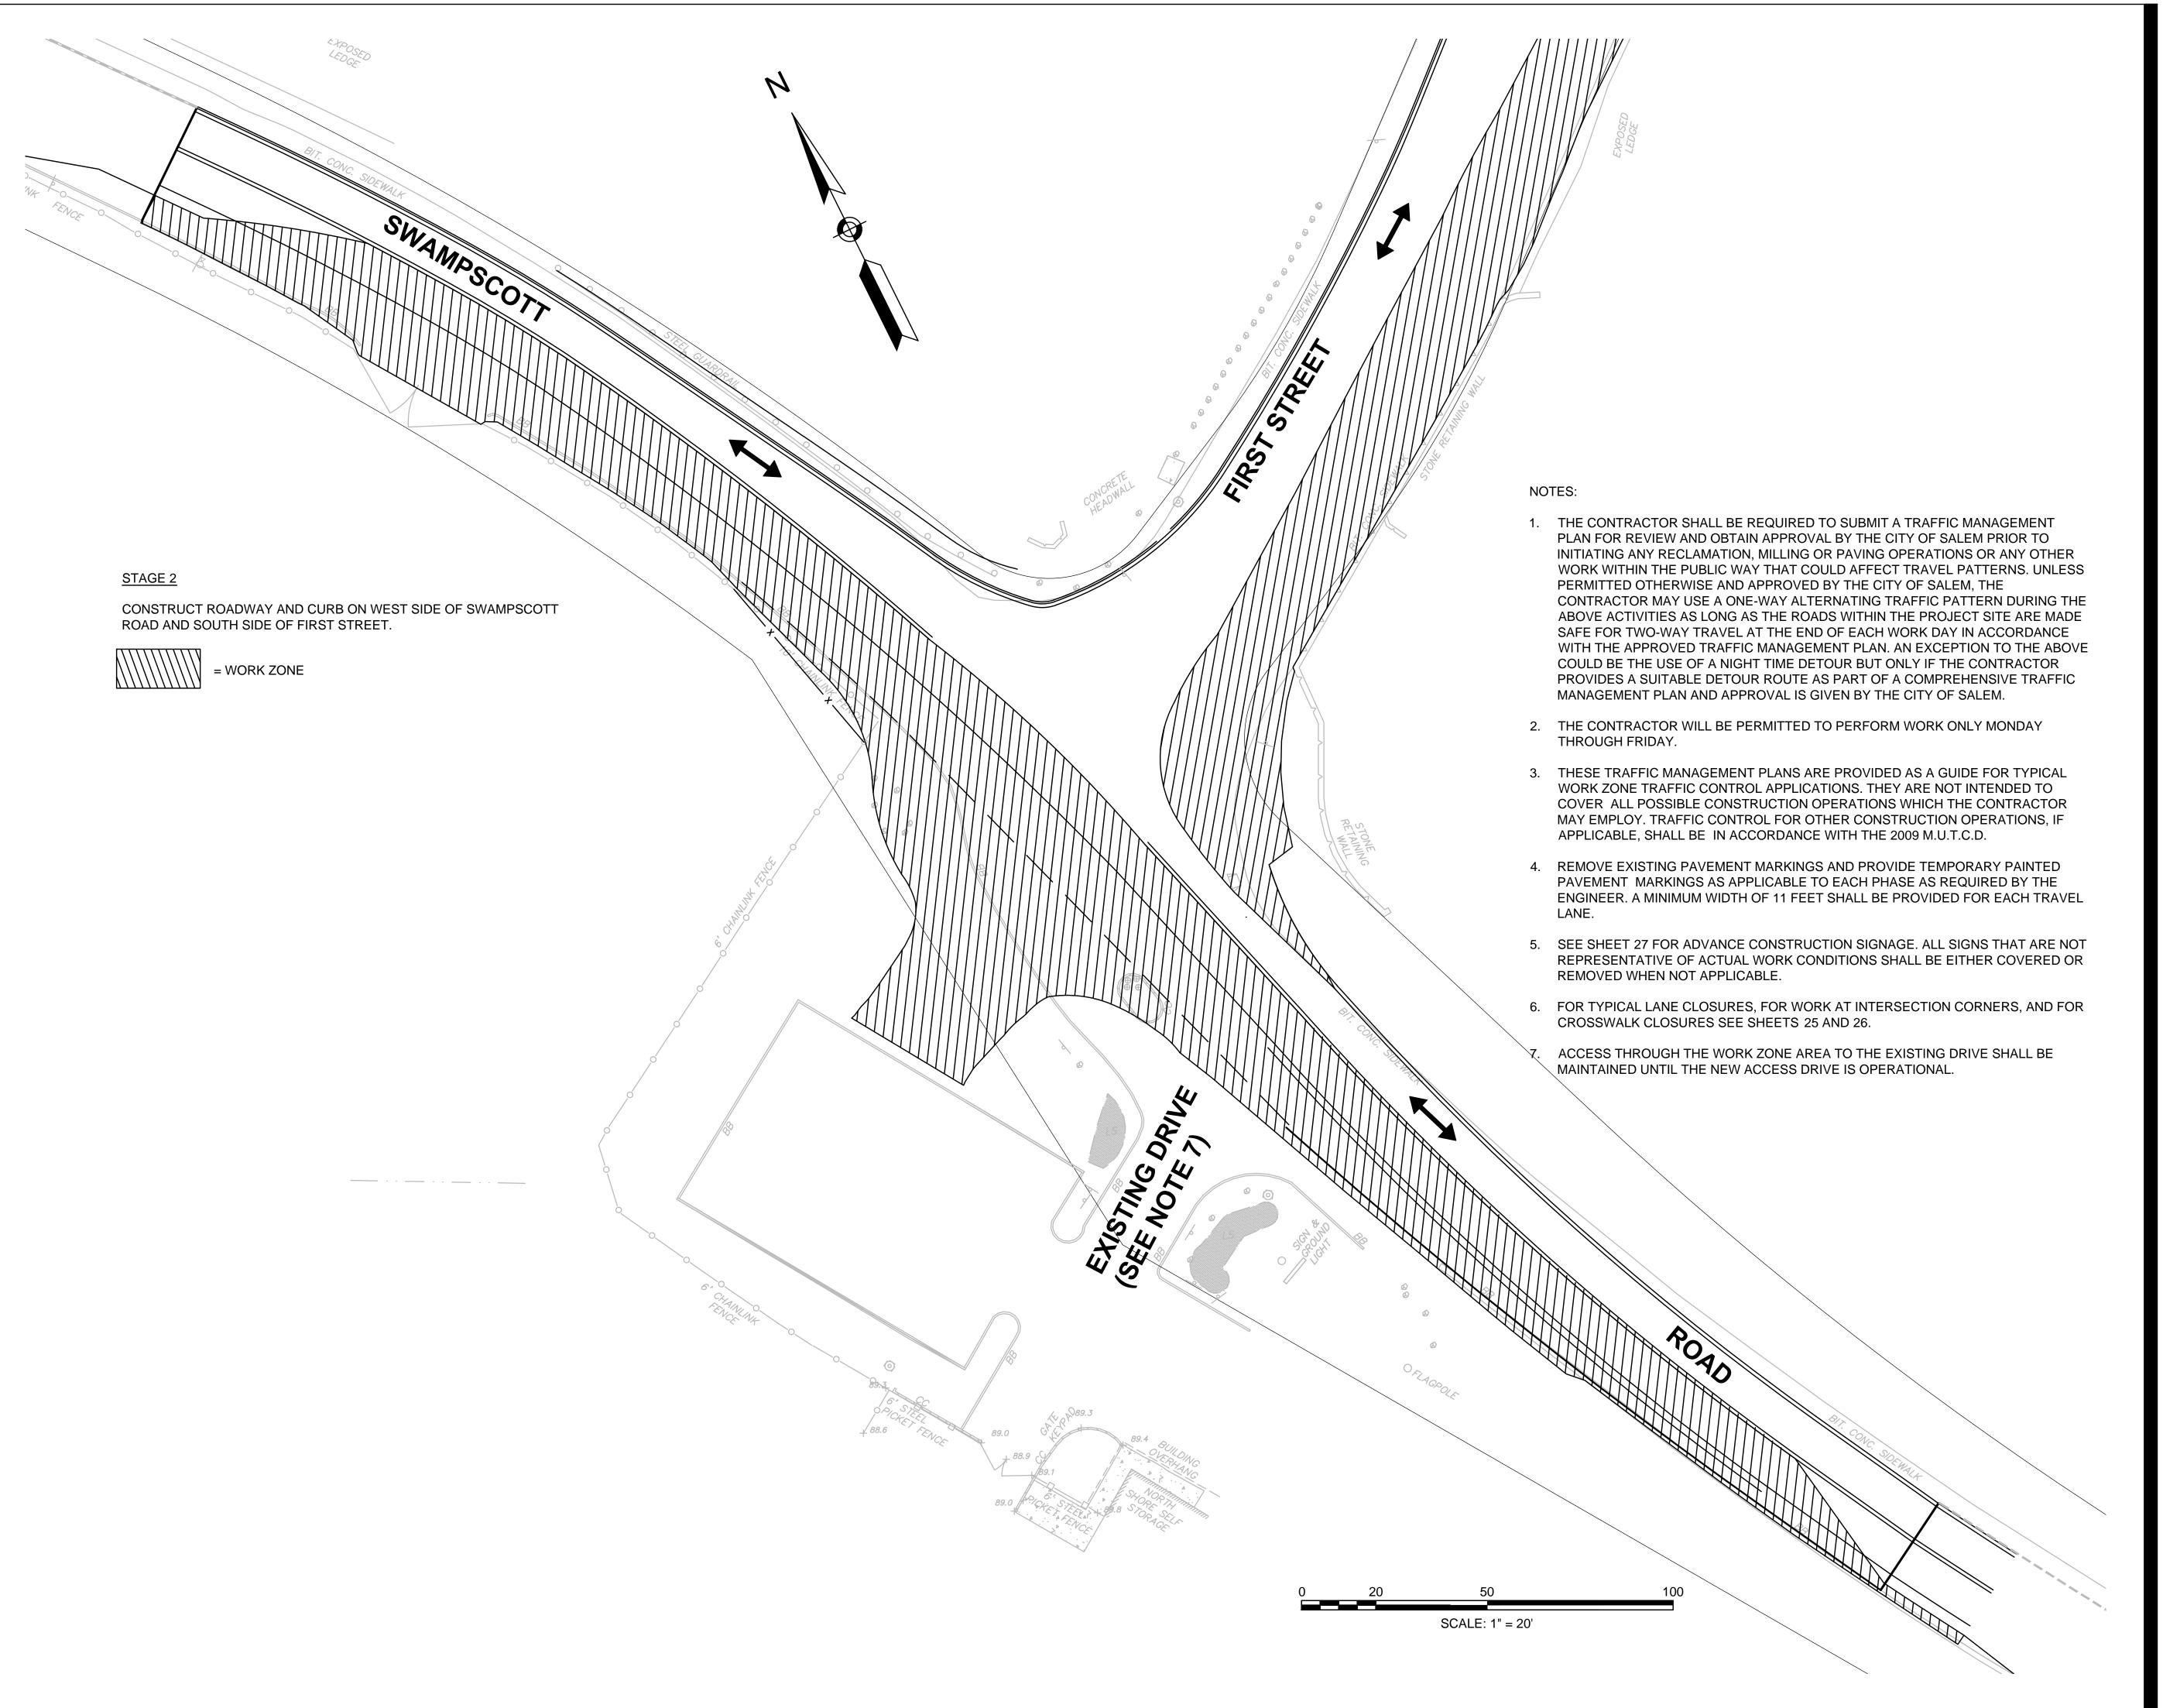



Stantec Consulting Services Inc. 5 Burlington Woods Drive, Suite 300

Burlington MA 01803 U.S.A. Tel. 781.221.1000 www.stantec.com

Copyright Reserved

The Contractor shall verify and be responsible for all dimensions. DO NOT scale the drawing - any errors or omissions shall be reported to The Copyrights to all designs and drawings are the property of Stantec. Reproduction or use for any purpose other than that authorized by Stantec is forbidden.

Consultants

File Name: ttcp plans.dwg Permit-Seal




Client/Project City of Salem, MA

> Swampscott Road at First Street Roundabout Construction Salem, MA

TEMPORARY TRAFFIC CONTROL PLANS -STAGE 2

Scale Project No. 1''=20' 179410490 Drawing No. Sheet

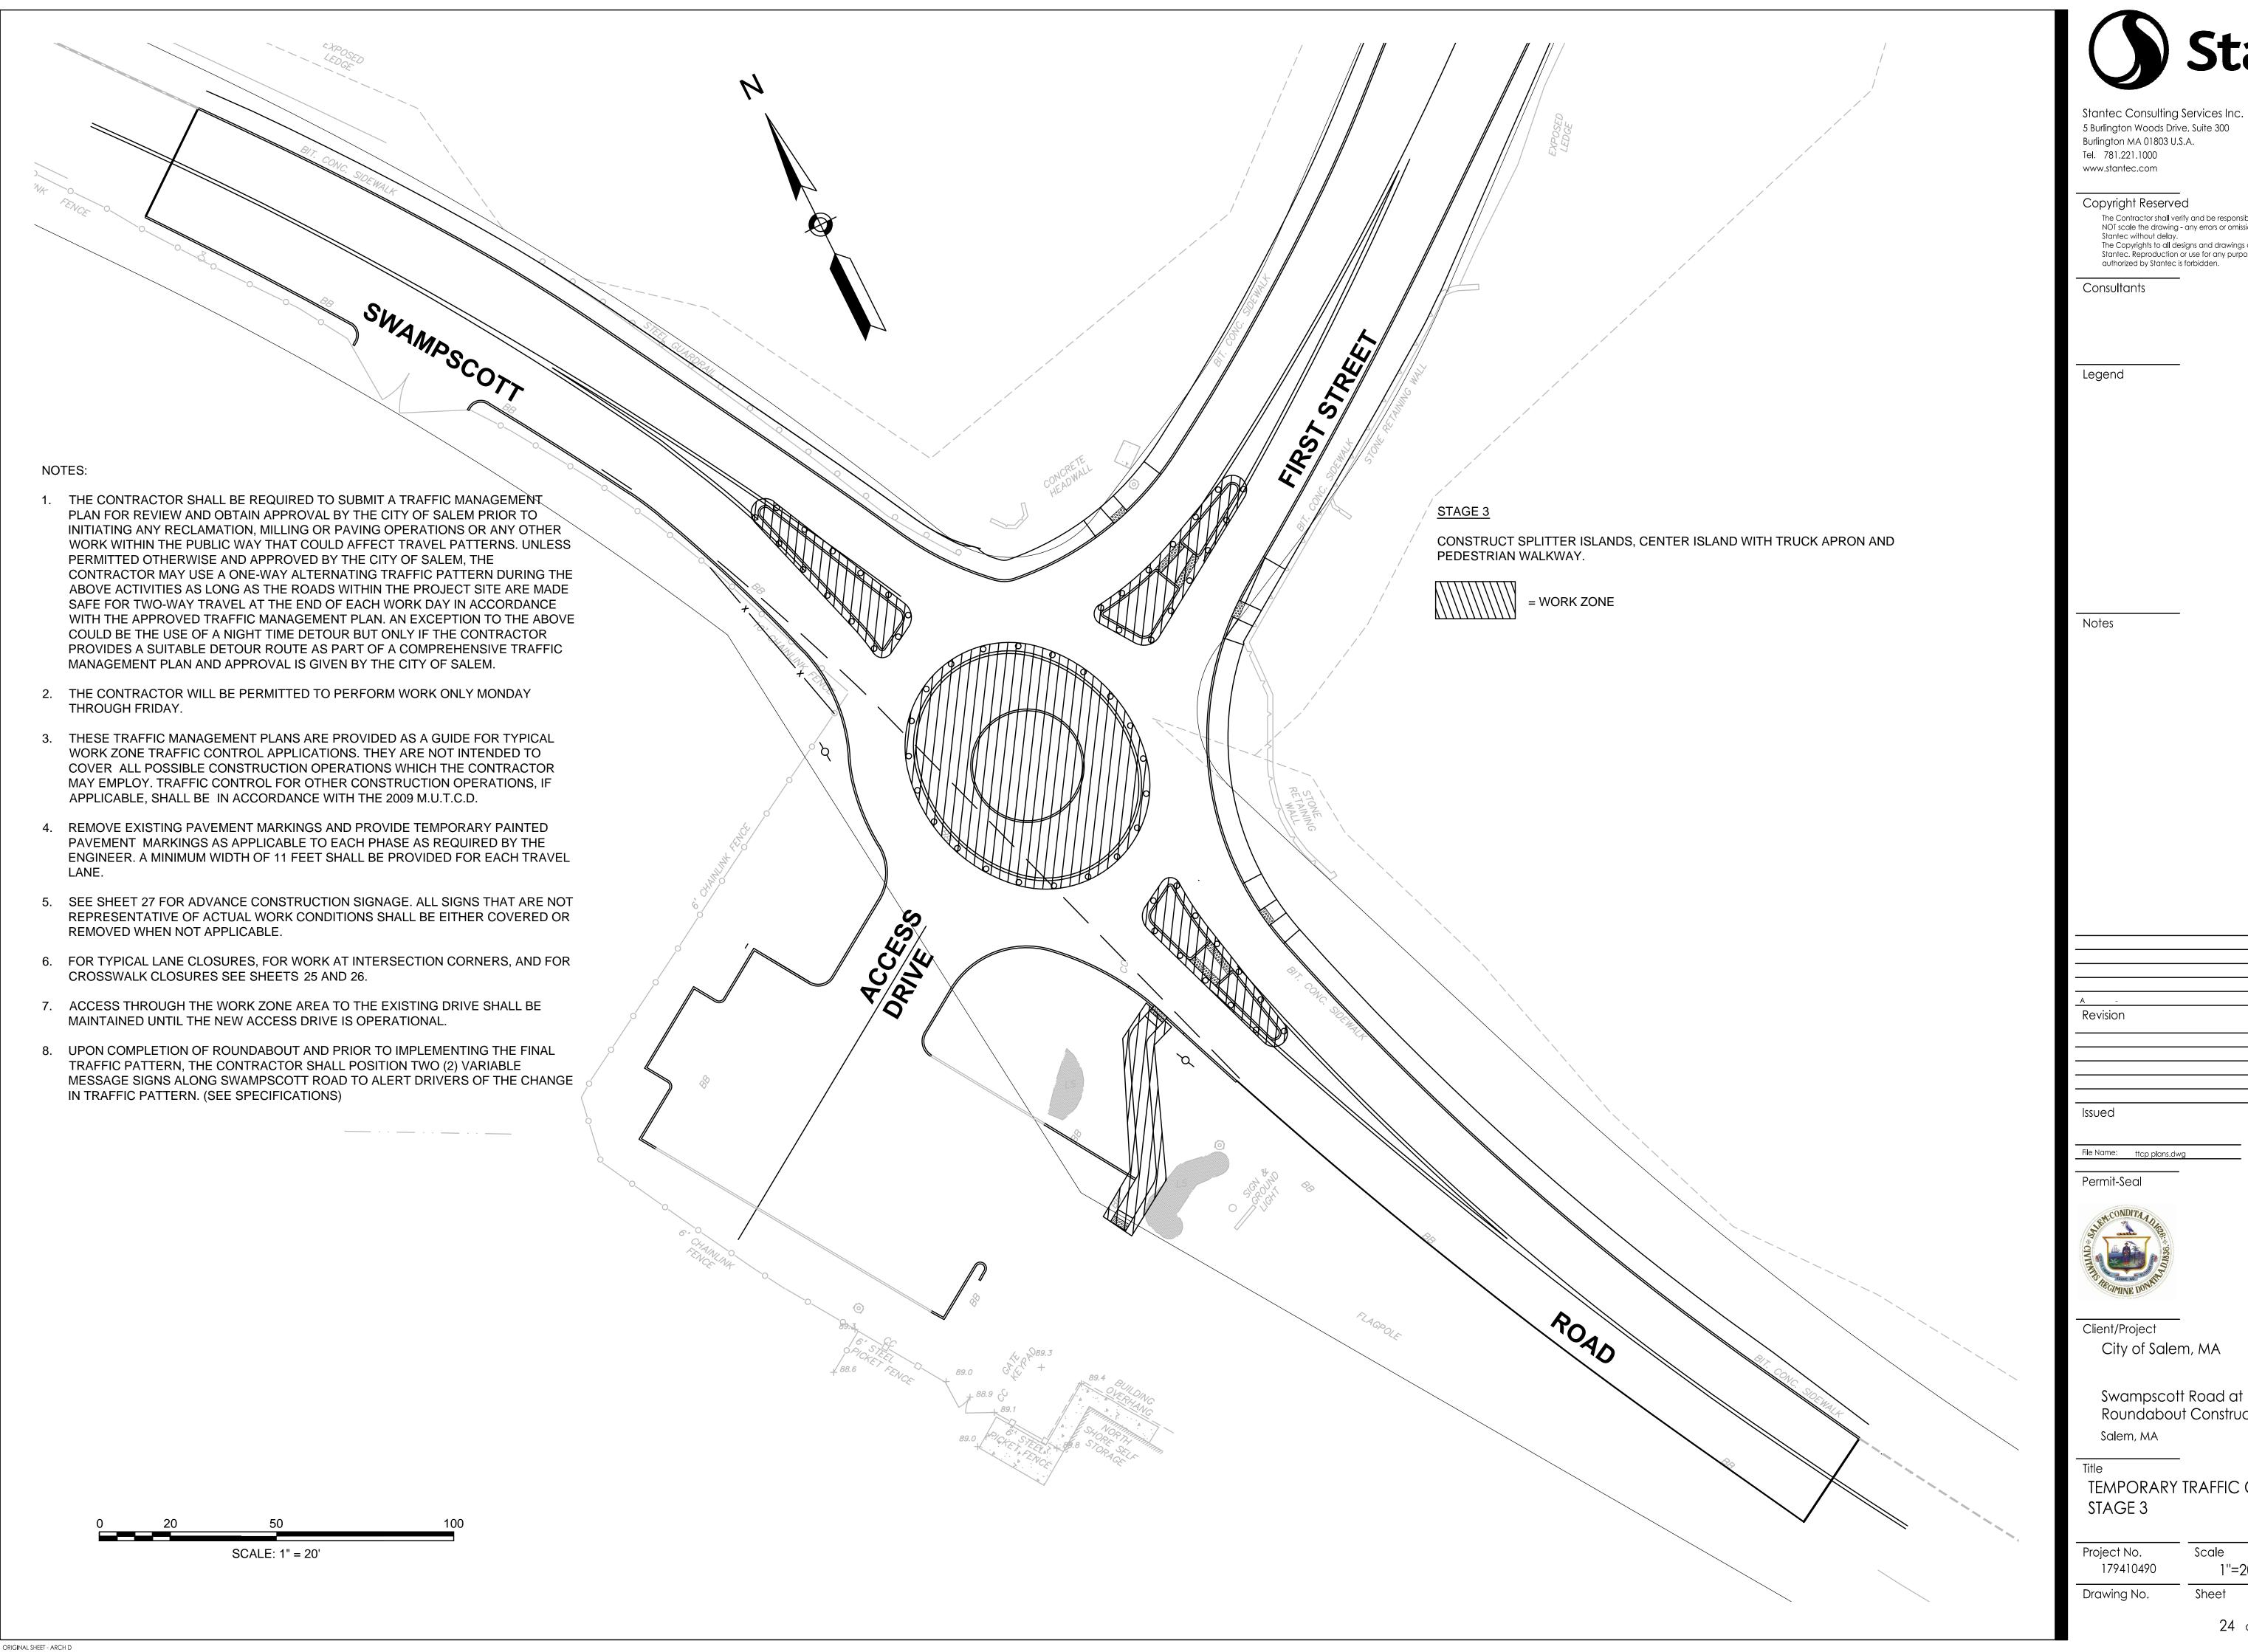

The Contractor shall verify and be responsible for all dimensions. DO NOT scale the drawing - any errors or omissions shall be reported to The Copyrights to all designs and drawings are the property of Stantec. Reproduction or use for any purpose other than that


Swampscott Road at First Street Roundabout Construction


TEMPORARY TRAFFIC CONTROL PLANS -

1''=20'


Revision

24 of 37

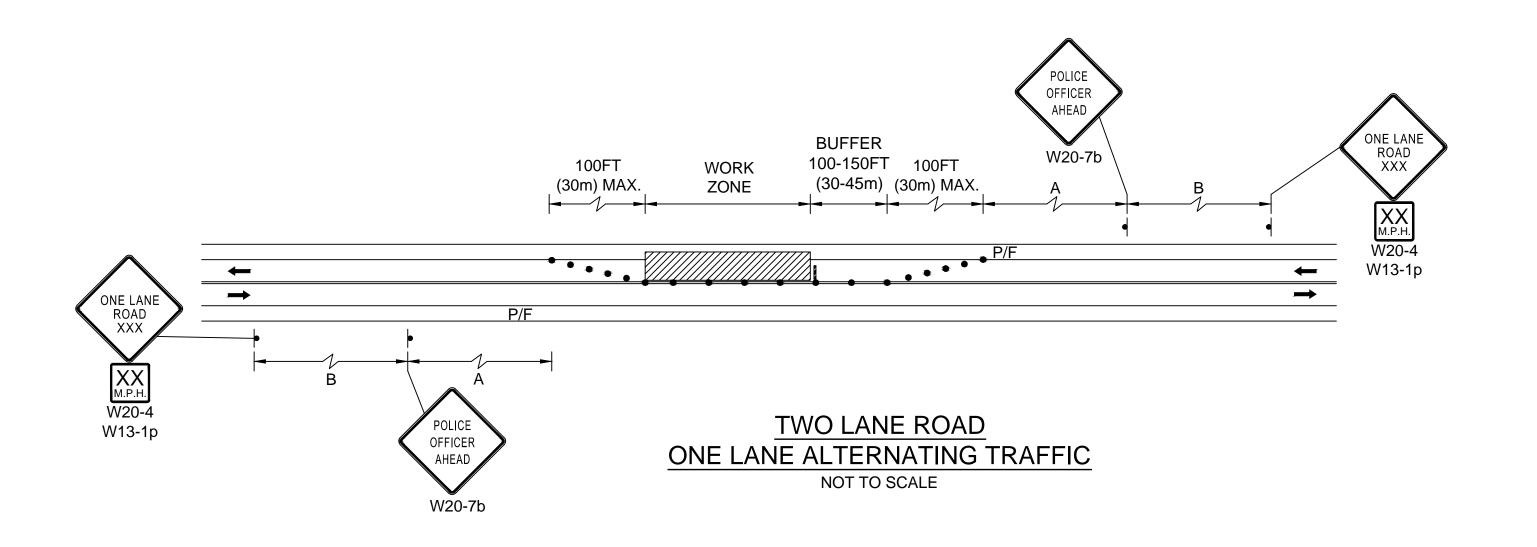

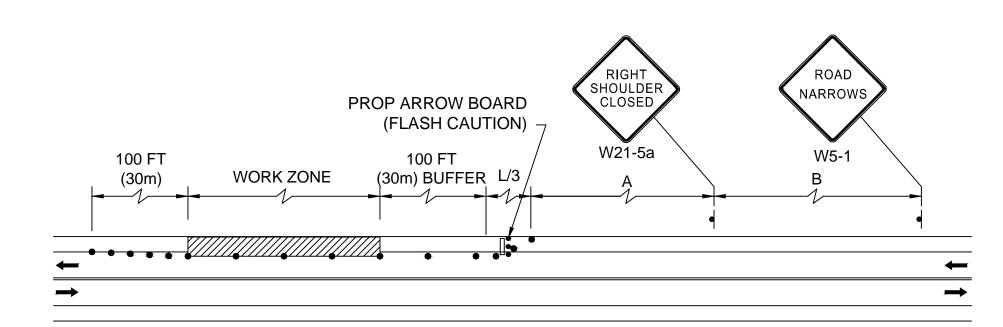

TWO LANE ROAD SHOULDER CLOSED NOT TO SCALE

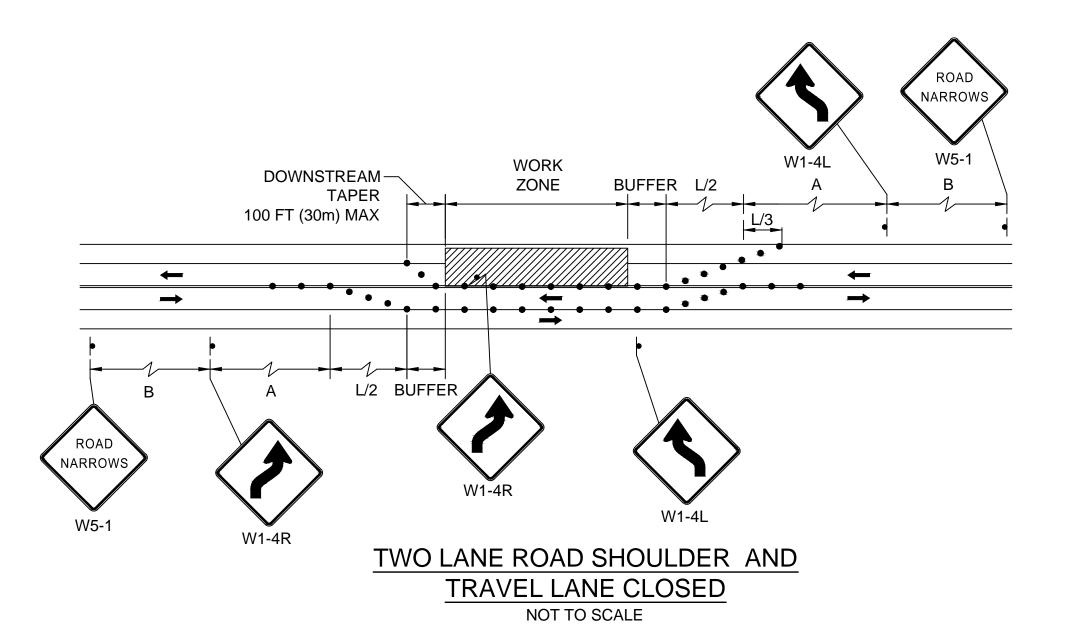



Stantec Consulting Services Inc. 5 Burlington Woods Drive, Suite 300 Burlington MA 01803 U.S.A. Tel. 781.221.1000 www.stantec.com

Copyright Reserved

The Contractor shall verify and be responsible for all dimensions. DO NOT scale the drawing - any errors or omissions shall be reported to The Copyrights to all designs and drawings are the property of Stantec. Reproduction or use for any purpose other than that authorized by Stantec is forbidden.

Consultants

File Name: ttcp plans.dwg Permit-Seal



Client/Project City of Salem, MA

Swampscott Road at First Street Roundabout Construction Salem, MA

TEMPORARY TRAFFIC CONTROL PLANS -TYPICALS PART 1 OF 3

Scale Project No. 1''=20' 179410490

Drawing No.


Sheet Revision

25 of 37


ORIGINAL SHEET - ARCH D

TEMPORARY MARKING FOR CROSSWALK LINES (CROSS-HATCHING OPTIONAL) SIDEWALK CLOSE W11-2 PEDESTRIAN USE OTHER SIDE R9-10 CROSSWALK W16-7pL SIDEWALK CLOSE (OPTIONAL) **USE OTHER SIDE** R9-10 300 FT W11-2 W16-9p SIDEWALK CLOSE AHEAD CROSS HERE 300 FT AHEAD W11-2 SIDEWALK CLOSED W16-9p CROSS HERE FOR LONG-TERM STATIONARY WORK, THE DOUBLE YELLOW CENTERLINE AND/OR LANE LINES SHOULD BE REMOVED BETWEEN THE CROSSWALK LINES.

PEDESTRIAN DETOUR NOT TO SCALE

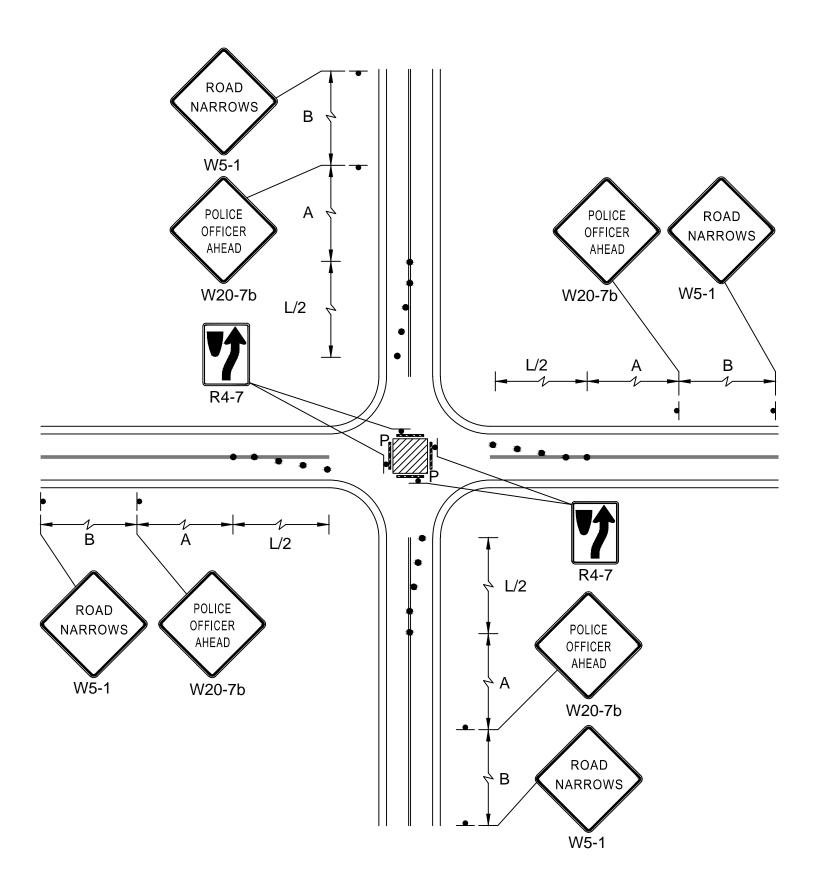

SINGLE LANE APPROACH **CENTER CLOSURE**

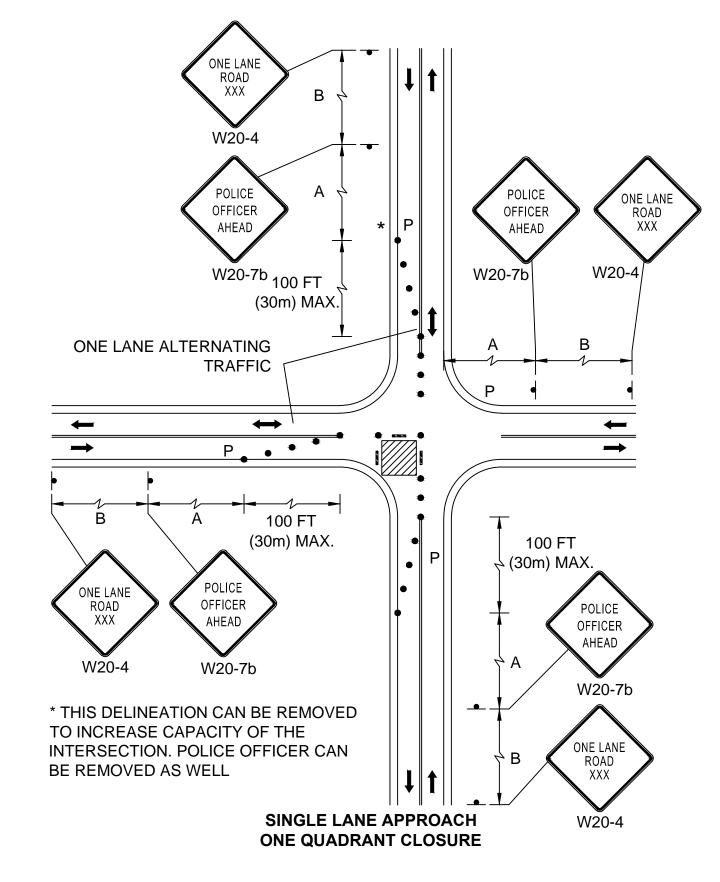

SUGGESTED WORK ZONE WARNING SIGN SPACING

Road Type	Distance Between Signs**							
	Α	В	С					
LOCAL OR LOW VOLUME ROADWAYS*	350	350	350					
MOST OTHER ROADWAYS*	500	500	500					
FREEWAYS AND EXPRESSWAYS*	1,000	1,500	2,640					

* SPEED CATEGORY TO BE DETERMINED BY HIGHWAY AGENCY

** DISTANCES ARE SHOWN IN FEET (METERS). THE COLUMN HEADINGS A, B, AND C ARE THE DIMENSIONS SHOWN IN THE DETAIL/ TYPICAL SETUP FIGURES. THE A DIMENSION IS THE DISTANCE FROM THE TRANSITION OR POINT OF RESTRICTION TO THE FIRST SIGN. THE B DIMENSION IS THE DISTANCE BETWEEN THE FIRST AND SECOND SIGNS. THE C DIMENSION IS THE DISTANCE BETWEEN THE SECOND AND THIRD SIGNS. (THE "THIRD" SIGN IS THE FIRST ONE TYPICALLY ENCOUNTERED BY A DRIVER APPROACHING A TEMPORARY TRAFFIC CONTROL (TTC) ZONE.)

THE "THIRD" SIGN ABOVE IS TYPICALLY REFERRED TO AS AN "ADVANCE WARNING" SIGN ON THE TMP SETUPS. IT IS THE ONE WHICH MAY OFTEN HAVE THE "STANDARD RED OR RED-ORANGE FLAGS (16 in. X 16 in.)" MOUNTED ON IT. THESE ADVANCE WARNING SIGNS ARE LOCATED AT THE PROJECT LIMITS ON ALL APPROACHES (i.e. THE W20-1 SERIES (ROAD WORK XX FT) SIGNS), AND USUALLY REMAIN FOR THE DURATION OF THE PROJECT.

THE FIRST AND SECOND WARNING SIGNS ABOVE ARE REFERRED TO AS THE OPERATIONAL (DAY-TO-DAY) WORK ZONE SIGNS AND MAY BE MOVED DEPENDING ON WHERE THE SPECIFIC ROADWAY WORK FOR THAT DAY IS LOCATED.

R2-10a SIGNS SHALL BE PLACED BETWEEN THE FIRST AND SECOND SIGNS.

R2-10a AND W20-1 SERIES SIGNS ARE TO BE INCLUDED ON ALL DETAILS/TYPICAL SETUPS.

TAPER LENGTH CRITERIA FOR TEMPORARY TRAFFIC CONTROL ZONES

Type of Taper	Taper Length (L)*
MERGING TAPER	AT LEAST L
SHIFTING TAPER	AT LEAST 0.5L
SHOULDER TAPER	AT LEAST 0.33L
ONE-LANE, TWO-WAY TRAFFIC TAPER	100 FT (30 m) MAXIMUM
DOWNSTREAM TAPER	100 FT (30 m) PER LANE

FORMULAS FOR DETERMINING TAPER LENGTHS

Speed Limit (S)	Taper Length (L) Feet
40 MPH OR LESS	$L = \frac{WS^2}{60}$
45 MPH OR MORE	L= WS

Speed Limit (S)	Taper Length (L) Meters
60 KM/H OR LESS	$L = \frac{WS^2}{155}$
70 KM/H OR MORE	L= WS 1.6

WHERE: L = TAPER LENGTH IN FEET (METERS)

W = WIDTH OF OFFSET IN FEET (METERS)

S = POSTED SPEED LIMIT, OR OFF-PEAK 85TH-PERCENTILE SPEED PRIOR TO WORK STARTING, OR THE ANTICAPATED OPERATING SPEED IN MPH (KM/H)

LEGEND

 REFLECTORIZED PLASTIC DRUM OR 36" CONE

P POLICE DETAIL TYPE III BARRICADE

CHANGEABLE MESSAGE SIGN ARROW BOARD

//// WORK ZONE

DIRECTION OF CONSTRUCTION TRAFFIC DIRECTION OF EXISTING TRAFFIC IMPACT ATTENUATOR

MEDIAN BARRIER

WORK VEHICLE TRUCK MOUNTED ATTENUATOR

→ TRAFFIC OR PEDESTRIAN SIGNAL

—O CONSTRUCTION SIGN

Project No. 179410490

Drawing No.

Revision

26 of 37

ORIGINAL SHEET - ARCH D

Burlington MA 01803 U.S.A. Tel. 781.221.1000 www.stantec.com Copyright Reserved The Contractor shall verify and be responsible for all dimensions. DO NOT scale the drawing - any errors or omissions shall be reported to The Copyrights to all designs and drawings are the property of Stantec. Reproduction or use for any purpose other than that authorized by Stantec is forbidden. Consultants Legend

Stantec Consulting Services Inc.

5 Burlington Woods Drive, Suite 300

File Name: ttcp plans.dwg SEARAASEA17.09.06Dwn.Chkd.Dsgn.YY.MM.DD

Permit-Seal

Notes



Client/Project City of Salem, MA

Swampscott Road at First Street Roundabout Construction Salem, MA

TEMPORARY TRAFFIC CONTROL PLANS -TYPICALS PART 2 OF 3

> Scale NOT TO SCALE


> > Sheet

CONSTRUCTION SIGN SUMMARY

IDENTIFI-	SIZE C	F SIGN	TEVE	TE	KT DIM	ENSIC	DNS	NUMBER OF		COLOR		POST SIZE AND	AREA IN
CATION NUMBER	WIDTH	HEIGHT	TEXT	LETTER HEIGHT	VER1		ARROV	SIGNS	BACK- GROUND	LEGEND	BORDER	NUMBER REQUIRED	SQUARE FEET
MA-R2-10a	48"	36"	WORK ZONE SPEEDING	SEE MA	 SSDO	ΓSTAN	NDARDS	3	FLUOR. ORANGE	BLACK	BLACK		36.00
			DOUBLED						WHITE				
MA-R2-10e	36"	48"	END ROAD WORK					3	FLUOR. ORANGE	BLACK	BLACK		36.00
			DOUBLE FINES END	\			V		WHITE				
R4-7	24"	30"	7	SEE M	UTCD	STANI	DARDS	3	WHITE	BLACK	BLACK		15.00
R9-9	24"	12"	SIDEWALK CLOSED					2	WHITE	BLACK	BLACK		4.00
R9-10	24"	12"	SIDEWALK CLOSED USE OTHER SIDE					2	WHITE	BLACK	BLACK		4.00
R9-11	24"	18"	SIDEWALK CLOSED AHEAD CROSS HERE					2	WHITE	BLACK	BLACK		6.00
W1-4L	36"	36"						2	ORANGE	BLACK	BLACK		18.00
W1-4R	36"	36"						2	ORANGE	BLACK	BLACK		18.00
W5-1	36"	36"	ROAD					3	ORANGE	BLACK	BLACK		27.00
W11-2	30"	30"						4	ORANGE	BLACK	BLACK		25.00
W13-1P	24"	24"	XX M.P.H.					2	ORANGE	BLACK	BLACK		8.00
W16-7pL	24"	12"						2	ORANGE	BLACK	BLACK		4.00
W16-9p	24"	12"	AHEAD					2	ORANGE	BLACK	BLACK		4.00
W20-1c	36"	36"	ROAD WORK AHEAD					3	ORANGE	BLACK	BLACK		27.00
W20-4	36"	36"	ONE LANE ROAD XXX					3	ORANGE	BLACK	BLACK		27.00
W20-7	36"	36"		•	1		V	3	ORANGE	BLACK	BLACK		27.00
W20-7b	36"	36"	POLICE OFFICER AHEAD	SEE MA	\$SDO ⁻	Γ STAN	NDARDS	3	ORANGE	BLACK	BLACK		27.00

NOTE:
SUPER HIGH INTENSITY UNMETALIZED MICROPRISMATIC ELEMENT
REFLECTIVE SHEETING M9.30.0 TYPE VII, VIII, IX, OR X
SHALL BE USED FOR ALL SIGNS.

FLUOR. — FLUORESCENT

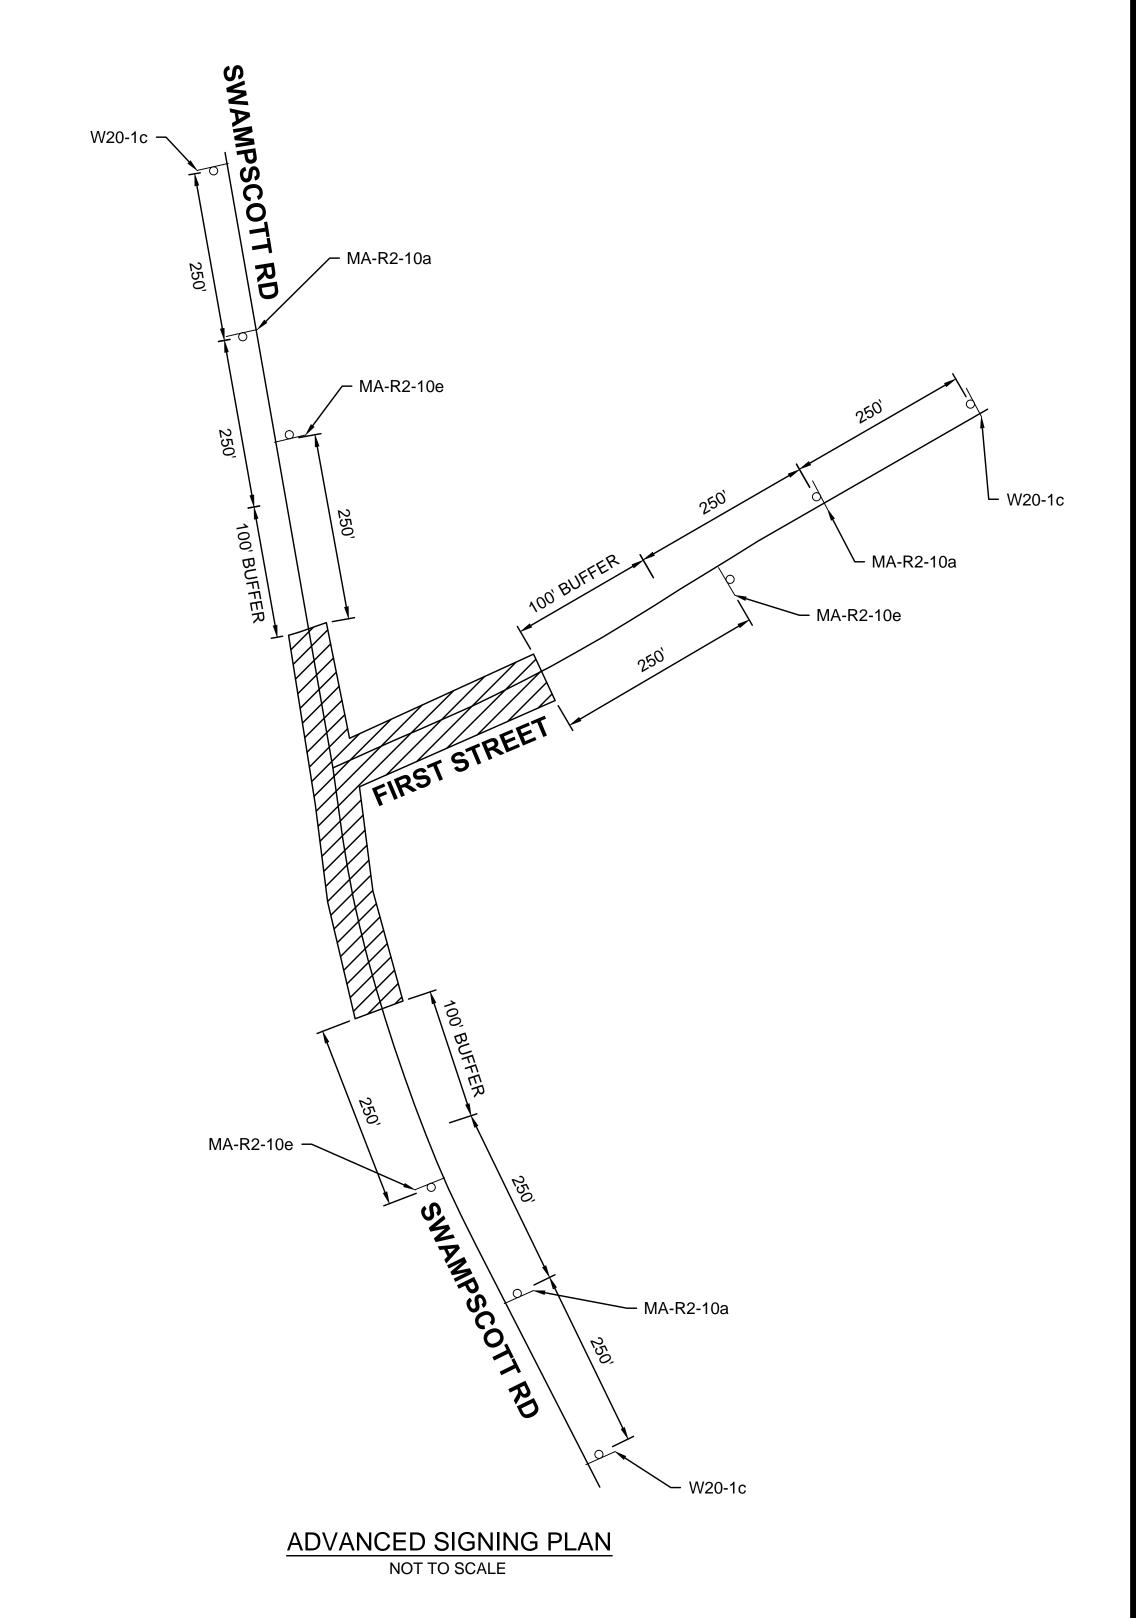



Stantec Consulting Services Inc. 5 Burlington Woods Drive, Suite 300 Burlington MA 01803 U.S.A. Tel. 781.221.1000

Copyright Reserved

www.stantec.com

The Contractor shall verify and be responsible for all dimensions. DO NOT scale the drawing - any errors or omissions shall be reported to Stantec without delay.

The Copyrights to all designs and drawings are the property of Stantec. Reproduction or use for any purpose other than that authorized by Stantec is forbidden.

Consultants

Leaend

Notes



Client/Project
City of Salem, MA

Swampscott Road at First Street Roundabout Construction

Title

TEMPORARY TRAFFIC CONTROL PLANS - TYPICALS PART 3 OF 3

Project No. Scale
179410490 NOT To

NOT TO SCALE

ABBREVIATIONS:

	AMPERES
FG	ABOVE FINISHED GRADE
WG	AMERICAN WIRE GAUGE
	CONDUIT
В	CIRCUIT BREAKER
KT	CIRCUIT
M	CIRCULAR MIL
U	COPPER
IA	DIAMETER
ND	GROUND
FCI	GROUND FAULT CIRCUIT INTERRUPTE
SNA	ILLUMINATING ENGINEERING SOCIETY
	OF NORTH AMERICA
VA	KILO VOLT AMPERES
C	LOAD CENTER
Τ	"L" LEFT
TG	LIGHTING
VC	POLYVINYL CHLORIDE
CPT	RECEPTACLE .
M	RIGID METAL CONDUIT
T	"R" RIGHT
CH	SCHEDULE
W	SIDEWALK


CONDUIT RUNS ARE DIAGRAMMATIC. COORDINATE CONDUIT RUNS WITH ALL OTHER EXISTING OR PROPOSED UNDERGROUND UTILITIES AND STRUCTURES.

GENERAL NOTES:

- PRIOR TO THE INSTALLATION OF PROPOSED LIGHTING, THE CONTRACTOR SHALL EXCAVATE TEST PITS AT LOCATIONS OF UTILITY CROSSINGS TO VERIFY DEPTHS AND LOCATIONS OF EXISTING PIPES, CONDUITS OR OTHER FACILITIES AND AS REQUIRED BY THE ENGINEER. WORK SHALL BE PAID FOR UNDER ITEM 141.1 TEST PIT FOR EXPLORATION.
- COORDINATE ELECTRIC SERVICE WITH ELECTRIC UTILITLY COMPANY (NATIONAL GRID). ALL WORK ASSOCIATED WITH THE ELECTRIC SERVICE MUST BE COMPLETED IN ACCORDANCE WITH ELECTRIC COMPANY STANDARDS.
- 4. ALL UTILITY BACK CHARGES ARE THE RESPONSIBILITY OF THE CONTRACTOR FOR ALL WORK PERTAINING TO THIS PROJECT. COORDINATE ALL PERMANENT AND TEMPORARY POWER WITH THE UTILITY.
- ALL ELECTRICAL EQUIPMENT SHALL BE UL LISTED FOR ITS INTENDED USE.
- PROVIDE GROUND CONDUCTOR IN EACH ELECTRICAL RACEWAY IN ACCORDANCE WITH THE CODE.
- THE HOT LINE AND NEUTRAL CONDUCTORS IN THE POLE HANDHOLE SHALL HAVE AN APPROVED STREET LIGHT FUSE CONNECTOR.

LUMINAIRE INFORMATION BOX

VOLTS WATTS

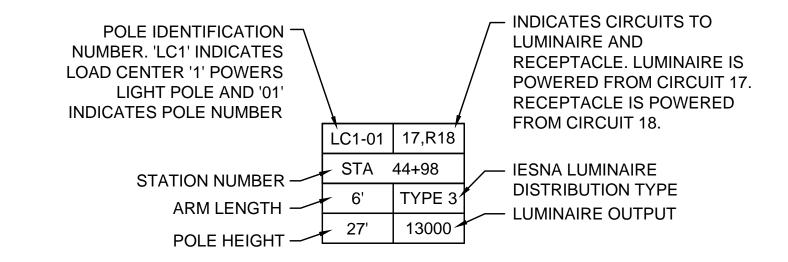

ELECTRICAL LEGEND:

LIGHTING CONDUIT DIRECT BURIED IN THE EARTH

CONDUIT TURNING DOWN

CONDUIT, CONCRETE ENCASED IIII

SINGLE LUMINAIRE WITH LIGHT POLE AND CONCRETE POLE FOUNDATION

LIGHTING CONTROL CABINET

PRE-CAST HANDHOLE



Stantec Consulting Services Inc. 5 Burlington Woods Drive, Suite 300 Burlington MA 01803 U.S.A. Tel. 781.221.1000

Copyright Reserved

www.stantec.com

The Contractor shall verify and be responsible for all dimensions. DO NOT scale the drawing - any errors or omissions shall be reported to The Copyrights to all designs and drawings are the property of Stantec. Reproduction or use for any purpose other than that authorized by Stantec is forbidden.

Consultants

Legend

Notes

By Appd. YY.MM.DD By Appd. YY.MM.DD File Name: lighting_details.dwg
 CN
 TJM
 DPH
 17.09.06

 Dwn.
 Chkd.
 Dsgn.
 YY.MM.DD
 Permit-Seal



Client/Project City of Salem, MA

Swampscott Road at First Street Roundabout Construction


Salem, MA

LIGHTING GENERAL NOTES AND LEGEND


Project No. Scale NOT TO SCALE 179410490 Drawing No.


28 of 37

ORIGINAL SHEET - ARCH D

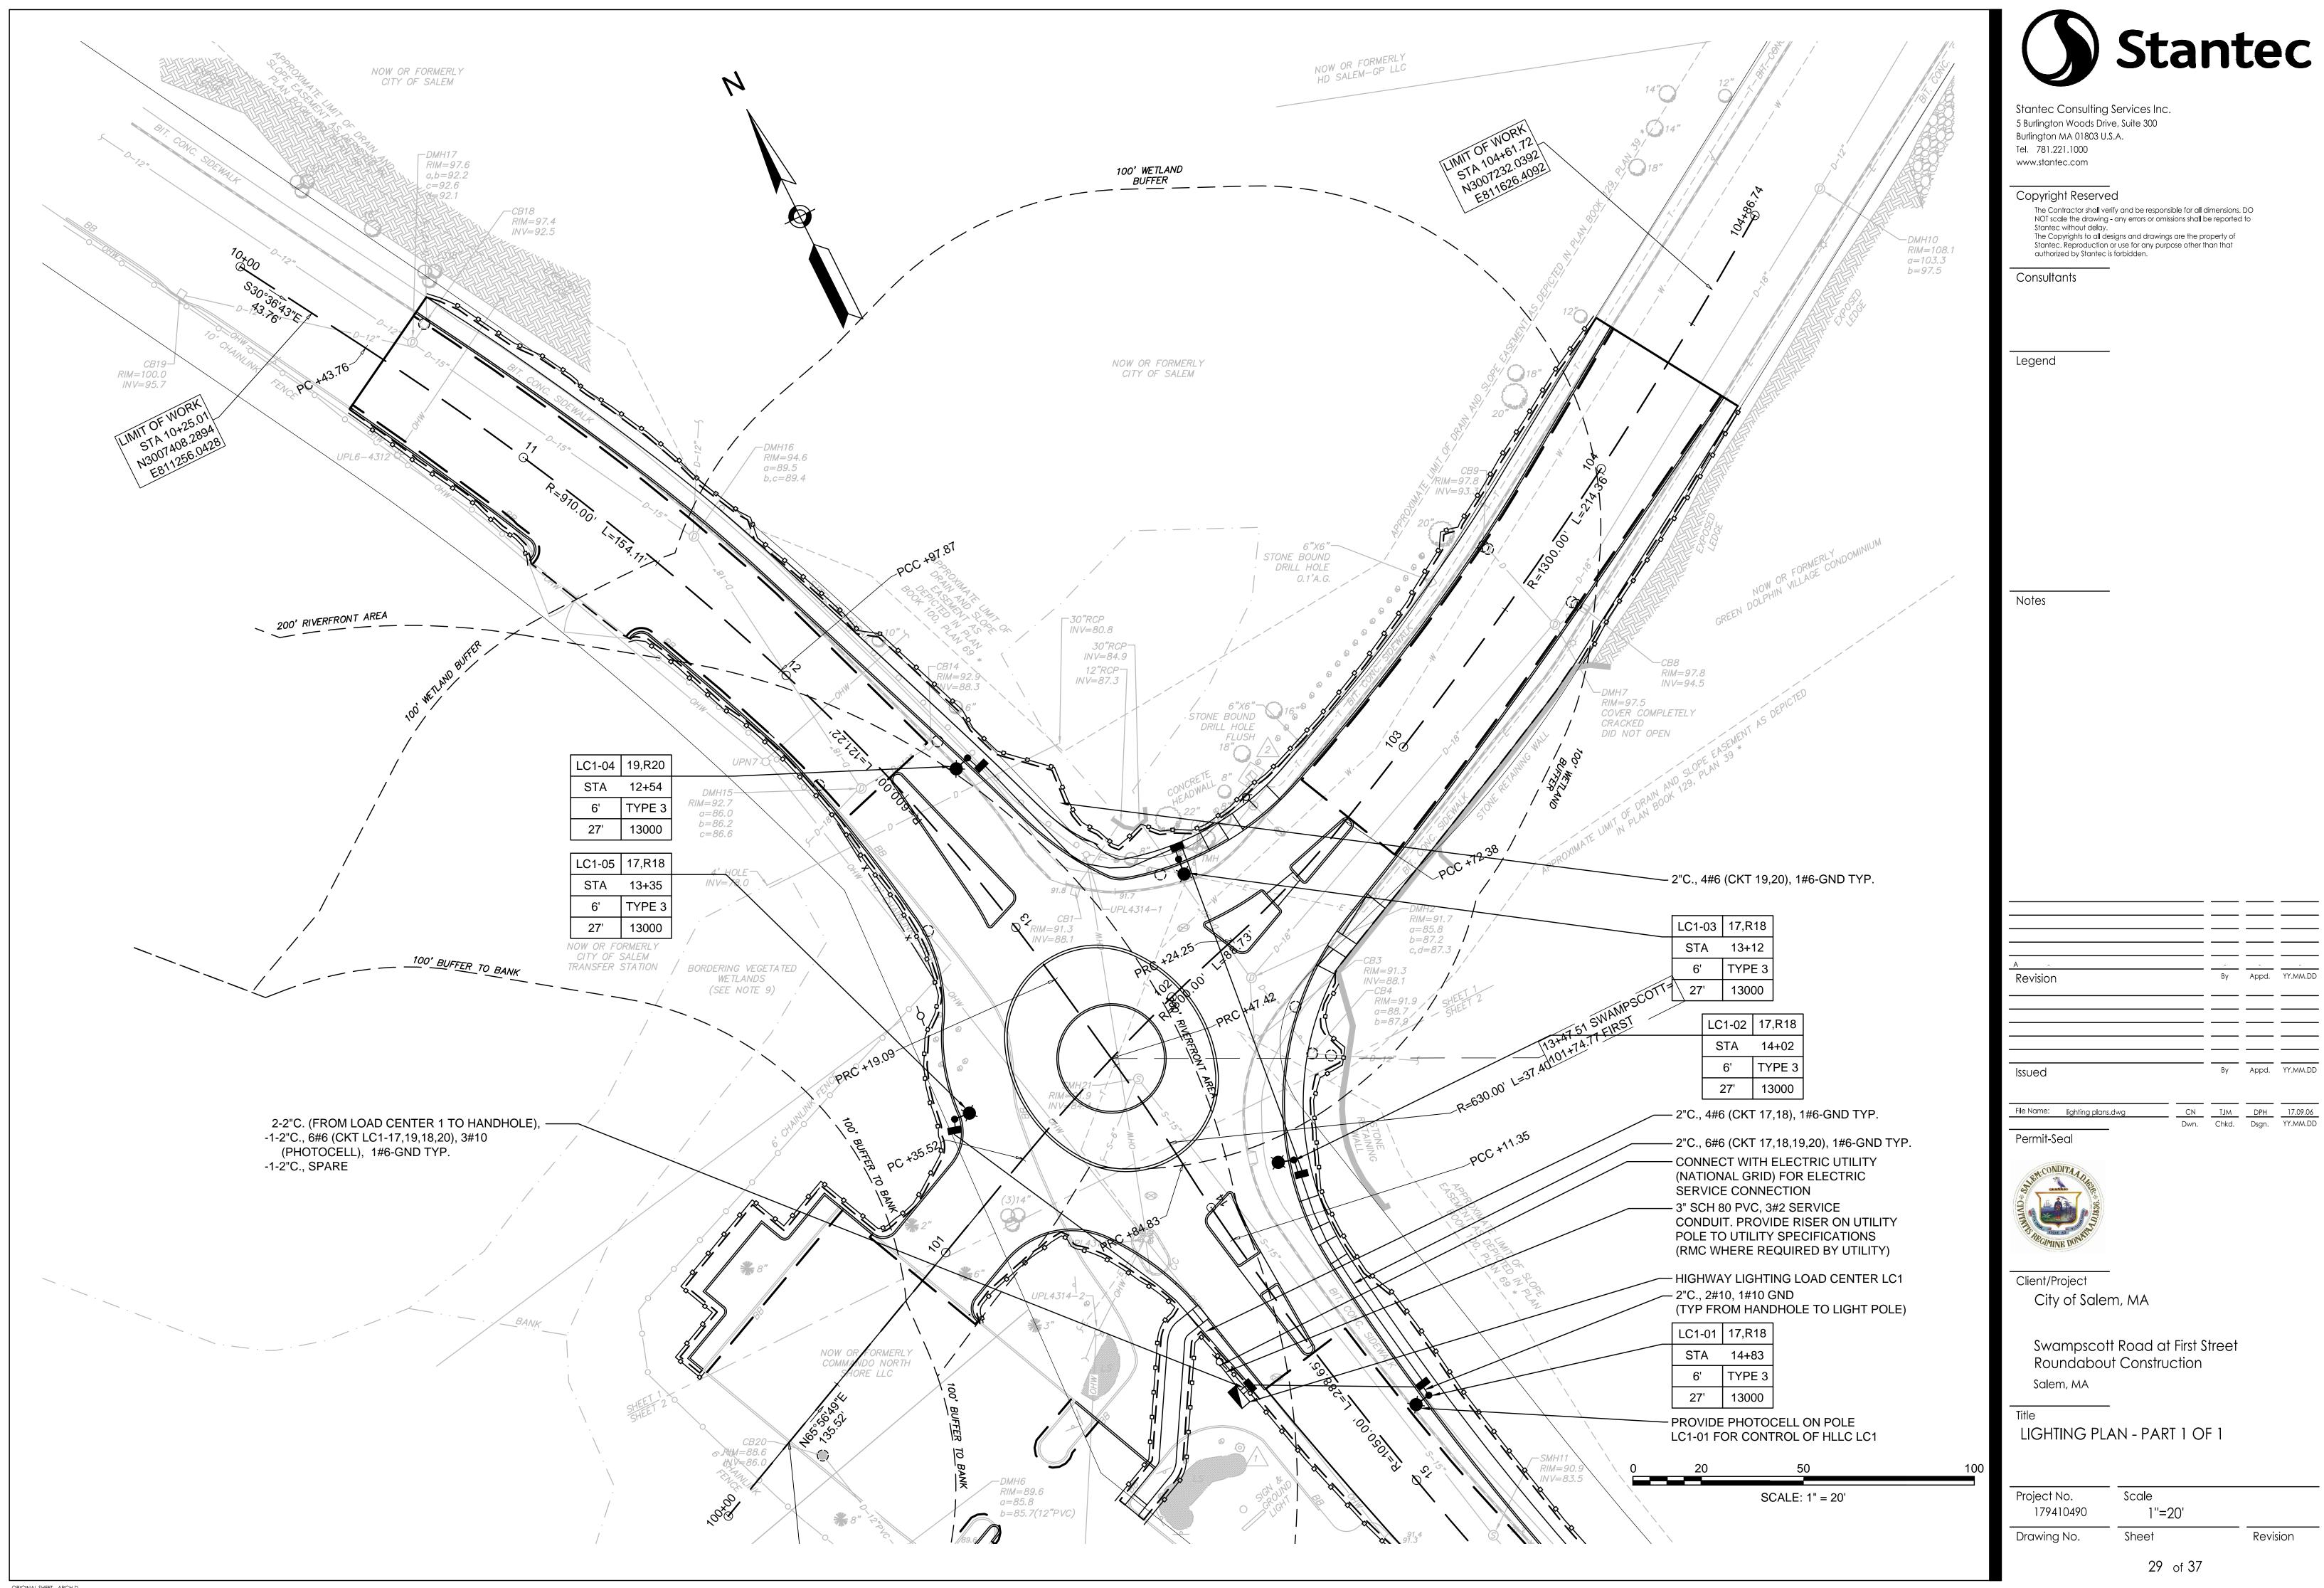


Stantec

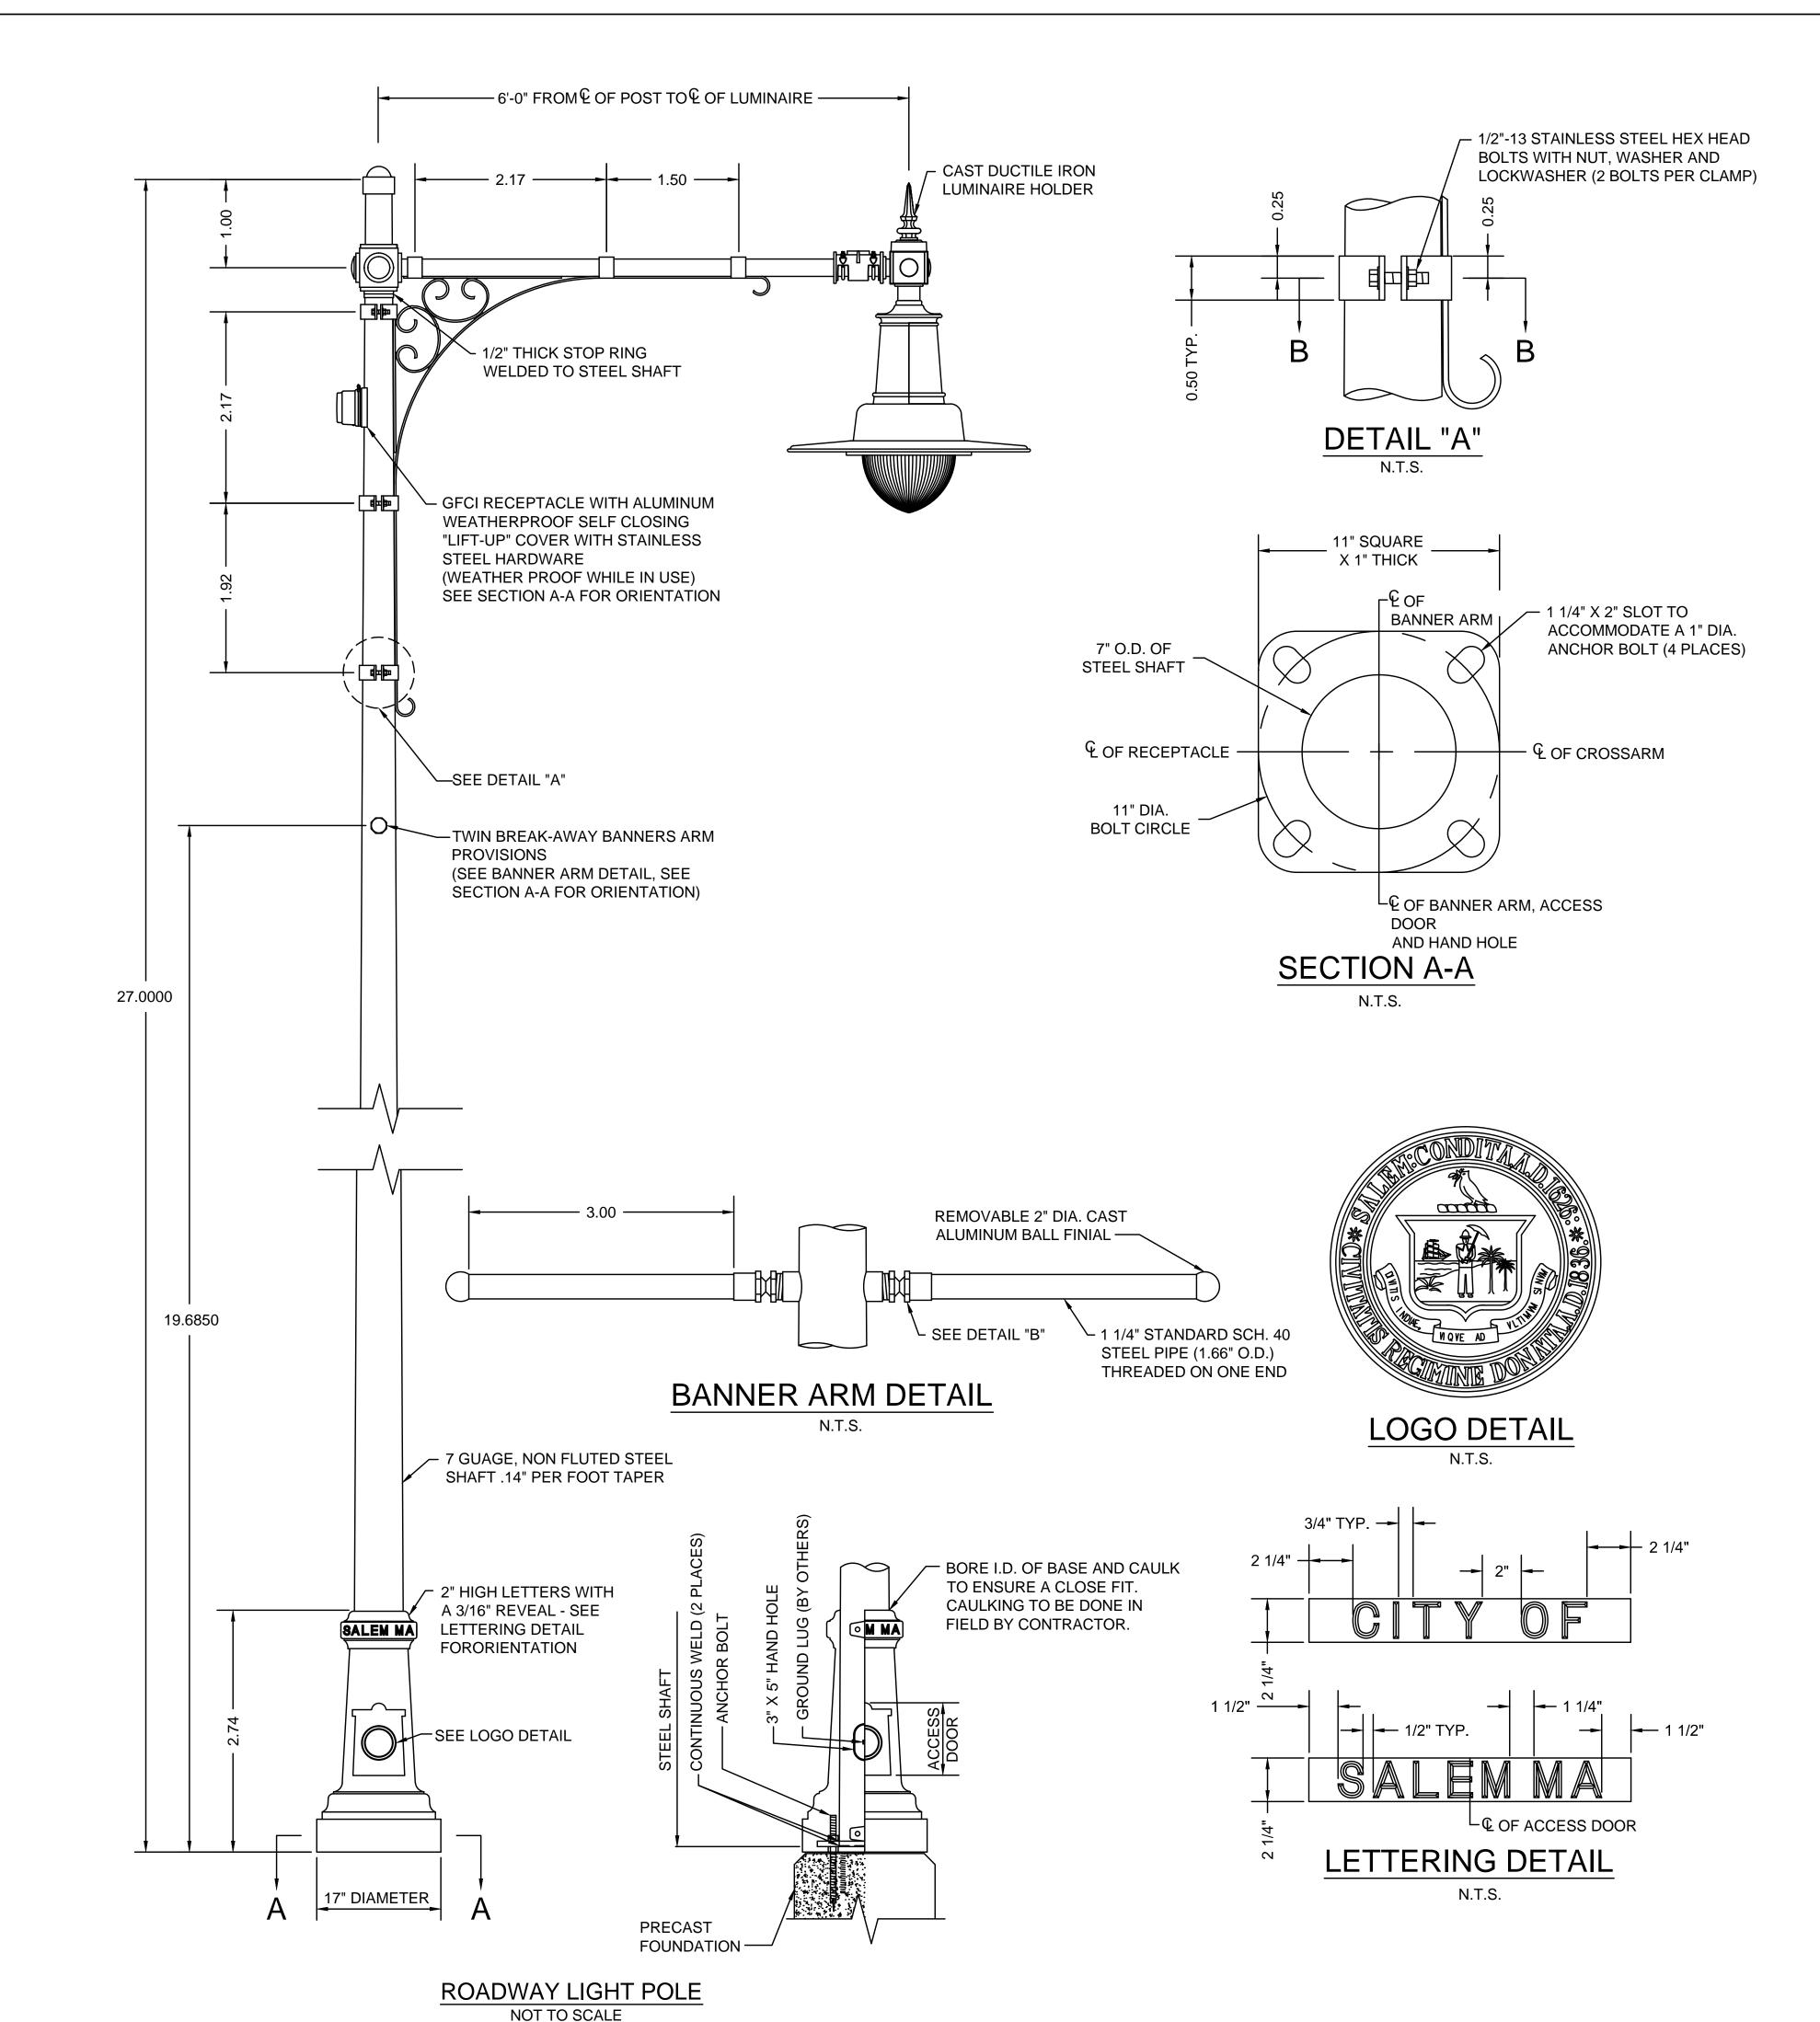

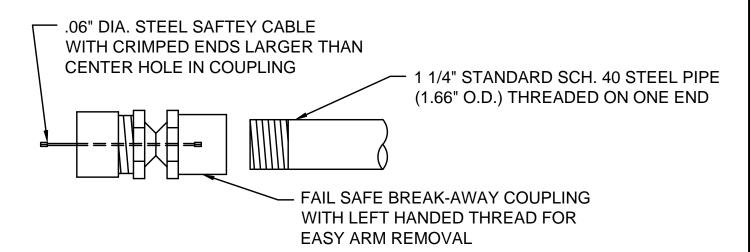

DETAIL "B" N.T.S.

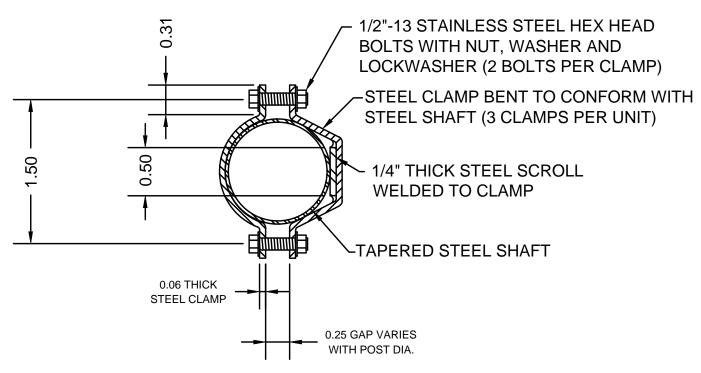

LUMINAIRE SPECIFICATIONS (ITEM NUMBER: 823.101)

STYLE: LECHMERE (ITEM NUMBER #: 823.101) **HEIGHT**: 2'-4 7/8"

SECTION B-B

N.T.S.

WIDTH: 2'9" DIA.

CAST ALUMINUM ALLOY ANSI 356 PER A.S.T.M. B26-95 MATERIAL:

COLUMBIA VERTICAL ALIGNMENT

GLOBE: RIBBED GLASS FINISH: POWDER COAT - GLOSS BLACK

LAMPING: 155W LED VOLTAGE: **ELECTRONIC WIRED AT 120-277**

NUM. OF BOARDS: 4500K

COLOR TEMP:

MODIFIER:

DISTRIBUTION: TYPE III (ASYMMETRIC DISTRIBUTION) **OPTICS:** CROSSFIRE REFRACTIVE

OUTPUT: 13,000 LUMEN MINIMUM

CROSS ARM SPECIFICATIONS (ITEM NUMBER: 821.3)

CAMBRIDGE SINGLE (ITEM NUMBER #: 821.3) STYLE: 6'-0" FROM OF POST TO OF LUMINAIRE WIDTH: MATERIAL: CAST DUCTILE IRON WITH 2" STANDARD STEEL PIPE AND STEEL SCROLL WORK FINISH: POWDER COAT - GLOSS BLACK

LAMP POST SPECIFICATIONS (ITEM NUMBER: 821.3)

CAMBRIDGE STEEL (CITY OF SALEM) STYLE: **HEIGHT**: 27'-0"

BASE: 17" DIAMETER MATERIAL:

SHAFT: 7 GAUGE, SMOOTH STEEL MONOTUBE CONSTRUCTION BASE: **DUCTILE IRON** FINISH:

SHAFT:

HOT DIPPED GALVANIZED & POWDER COAT - GLOSS BLACK BASE: POWDER COAT - GLOSS BLACK ACCESS DOOR: LOCATED IN BASE TO COINCIDE WITH HAND HOLE

> IN STEEL SHAFT SECURED WITH TAMPER PROOF HEX SOCKET SECURITY MACHINE SCREWS

GROUND STUD PROVISIONS:

1/4"-20 SQUARE NUT WELDED TO INSIDE WALL OF SHAFT OPPOSITE HAND HOLE FOR GROUND STUD (STUD BY OTHERS) **ANCHOR BOLTS:** (4) 1" DIA. X 36" + 4" HOOK (FULLY GALVANIZED WITH 2

GALVANIZED NUTS AND 2 GALVANIZED WASHERS PER BOLT)

BOLT PROJECTION: 5" REQUIRED



Stantec Consulting Services Inc. 5 Burlington Woods Drive, Suite 300 Burlington MA 01803 U.S.A. Tel. 781.221.1000

Copyright Reserved

www.stantec.com

The Contractor shall verify and be responsible for all dimensions. DO NOT scale the drawing - any errors or omissions shall be reported to The Copyrights to all designs and drawings are the property of Stantec. Reproduction or use for any purpose other than that authorized by Stantec is forbidden.

Consultants

Legend

Permit-Seal



File Name: lighting_details.dwg

Client/Project

City of Salem, MA

Swampscott Road at First Street Roundabout Construction

Salem, MA


Drawing No.

LIGHTING DETAILS - PART 1 OF 3

Scale Project No. NOT TO SCALE 179410490

Sheet

ORIGINAL SHEET - ARCH D

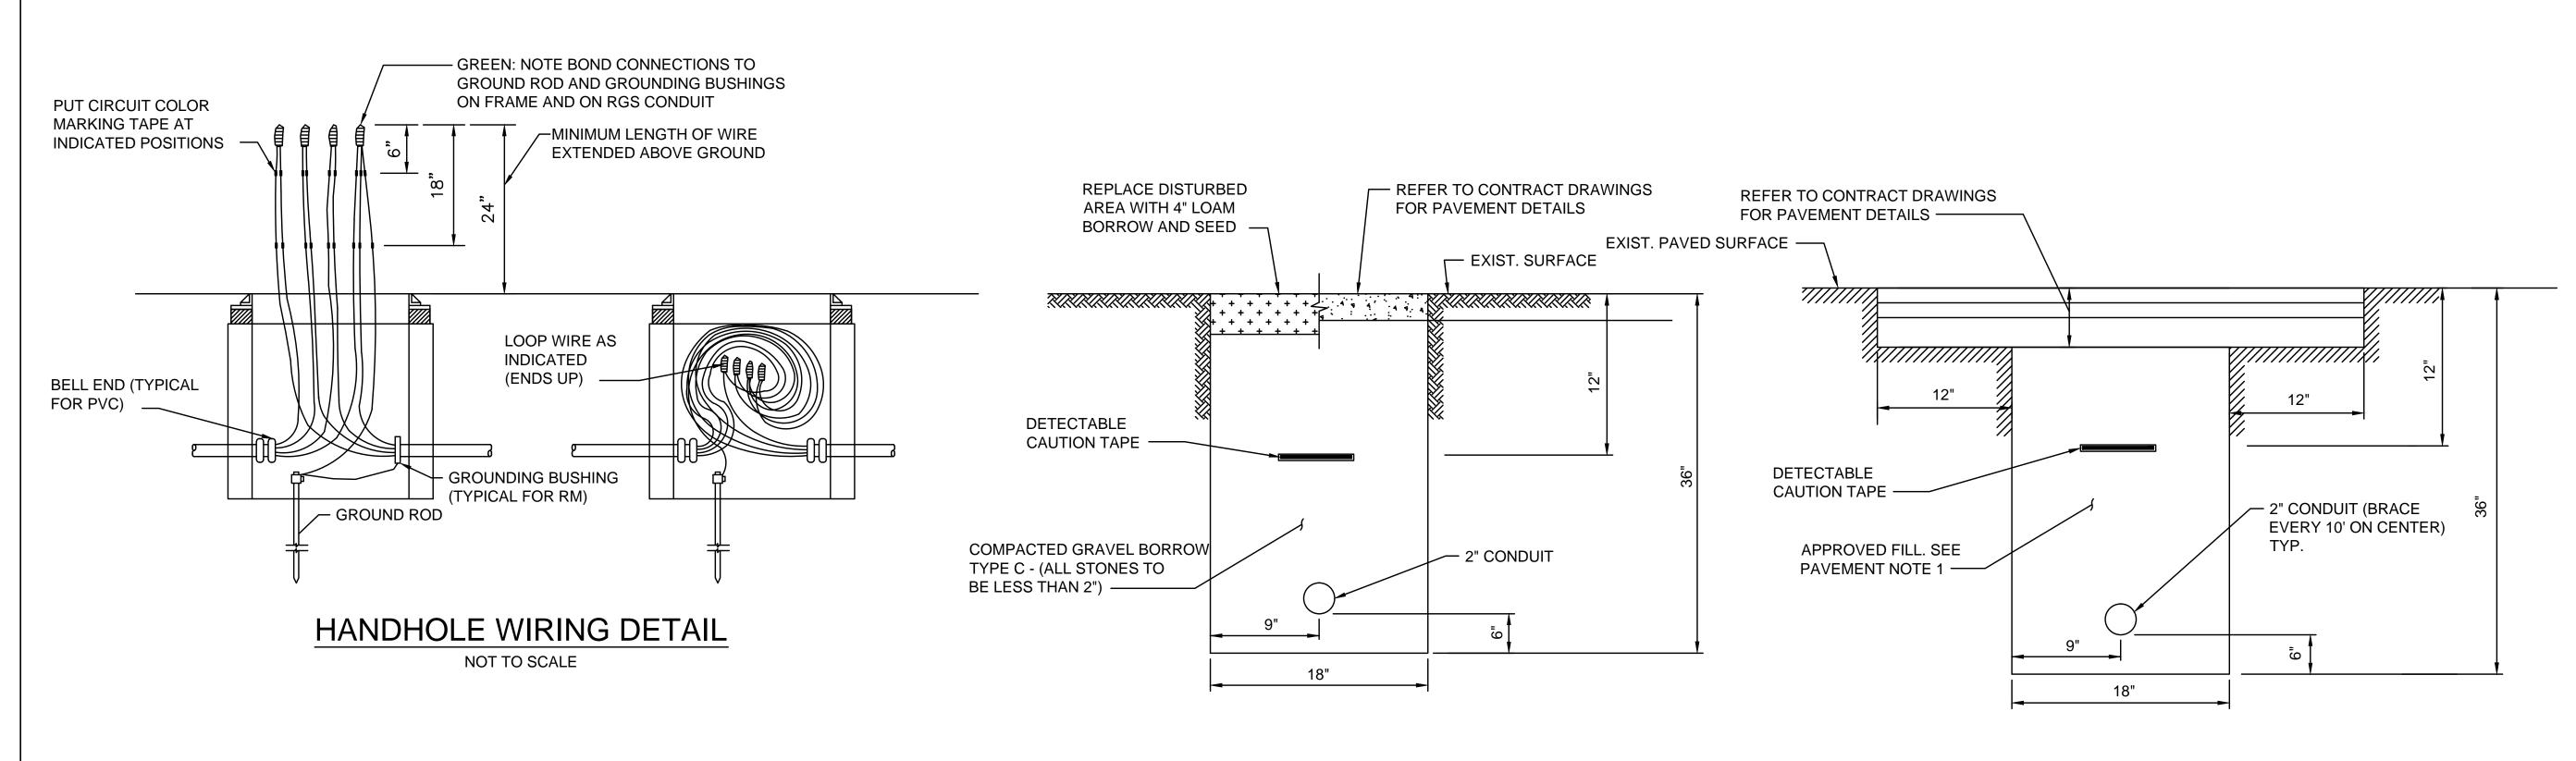

SINGLE CONDUIT (UNDER GRASS AREA

OR SIDEWALK)


CONDUIT UNDER ROADWAY

TYPICAL TRENCH DETAILS FOR CONDUIT

NOT TO SCALE

PAVEMENT NOTES FOR TRENCH PATCHING:

1. FOR TRENCH CUTS WITHIN PAVED SURFACES, (MAINLINE AND LOCAL ROADS) WHERE SUCH TRENCH CUTS HAVE A DEPTH OF 4' OR LESS, CONTROLLED DENSITY FILL (CDF) FOR BACKFILL IS MANDATORY. CONTROLLED DENSITY FILL TYPE 2E, (FLOWABLE-EXCAVATABLE)SHALL MEET THE REQUIREMENTS OF SECTION M4.08.0.

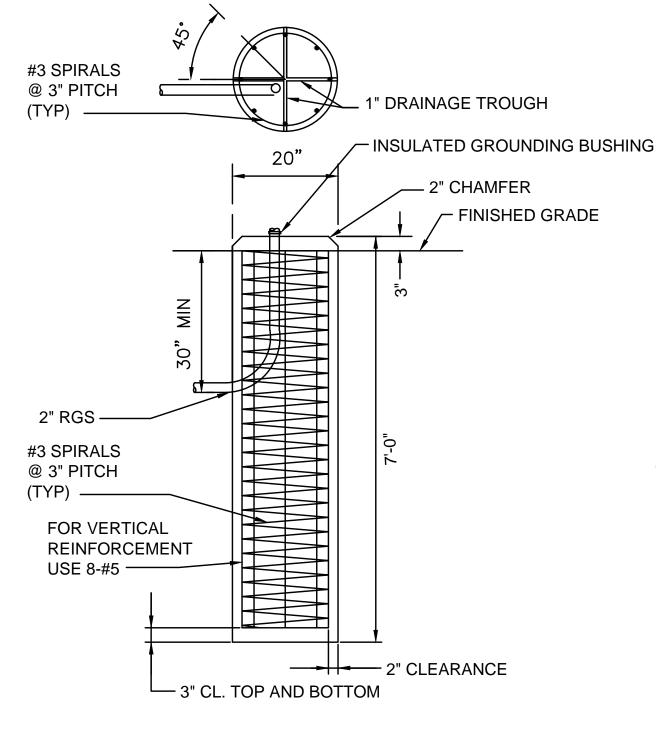


LIGHT STANDARD FOUNDATION NOTES:

- 1. CEMENT CONCRETE FOR FOUNDATIONS TO BE 4000 PSI, 1.5", 565 CEMENT CONCRETE. REINFORCING STEEL: SEE M4.03.05 OF THE STANDARD SPECIFICATIONS
- 2. A MINIMUM SLOPE OF 1/8" PER FOOT FROM EDGE OF BASE PLATE TO FACE OF CONCRETE.
- 3. THE ANCHOR BOLTS SHALL BE SUPPLIED BY THE LIGHT STANDARD MANUFACTURER. THE MANUFACTURER SHALL ALSO SUPPLY A TEMPLATE FOR SETTING THE BOLTS AND SHALL INDICATE THE NECESSARY PROJECTION.

HIGHWAY LIGHT STANDARD FOUNDATION

NOT TO SCALE

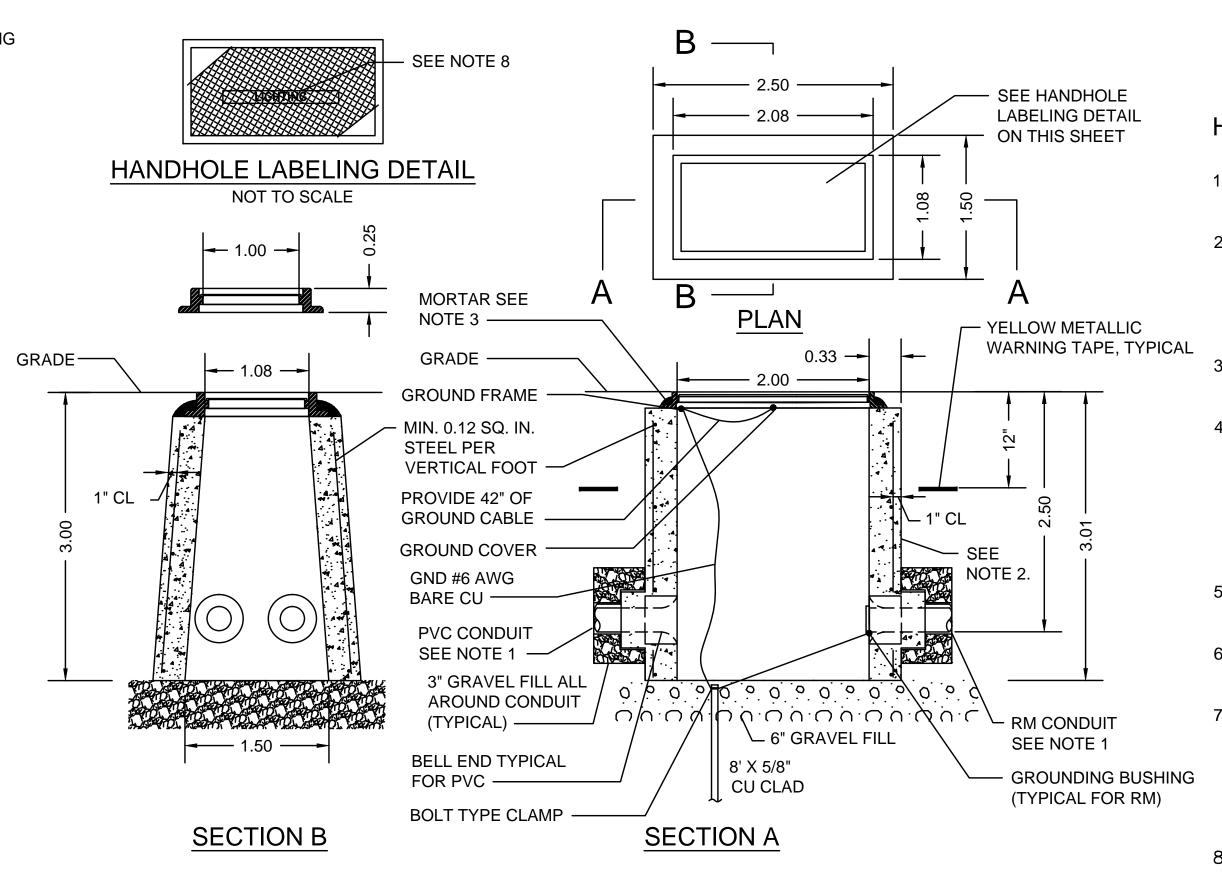

PRECAST CONCRETE ELECTRIC HANDHOLE

SIZE 24 X 13 X 36 (SD2-022)

NOT TO SCALE

HANDHOLE NOTES:

- 1. ALL CONDUIT ENTERING HANDHOLES SHALL EXTEND INTO THE HANDHOLE CAVITY BY AT LEAST 2".
- 2. ALL HANDHOLES SHALL BE PRECAST CONCRETE REINFORCED WITH STEEL, AND SHALL BE FREE OF CRACKS OR OTHER DEFECTS. CONCRETE FOR PRECAST CONCRETE HANDHOLES SHALL BE 5000 PSI, 3/8 IN., 660 CEMENT CONCRETE MASONRY. REINFORCING BARS SHALL CONFORM TO AASHTO DESIGNATION M31 (ASTM DESIGNATION A 615) GRADE 60. AND SHALL BE EPOXY COATED.
- 3. CAST IRON FRAME SHALL BE MORTARED TO THE SURFACE OF THE PRECAST HANDHOLE.
- 4. ALL CONDUIT INSTALLED IN HANDHOLES SHALL BE INSTALLED IN KNOCKOUTS PROVIDED IN THE BOX AND NO EXCESS KNOCKOUTS SHALL BE MADE. THE KNOCKOUTS ARE DESIGNED TO BE MADE PRIOR TO BACKFILLING AROUND THE HANDHOLES. AFTER THE CONDUIT HAS BEEN INSTALLED IN THE HANDHOLE, THE OPEN SPACE BETWEEN THE BOX AND THE CONDUIT WILL BE SEALED WITH CLASS B CEMENT CONCRETE MASONRY. ANY CONDUIT INSTALLED IN SUCH A MANNER AS TO BLOCK COMPLETE ACCESS TO ANY OTHER CONDUIT SHALL BE REMOVED AND RESET.
- 5. FOR THE EXACT NUMBER, SIZE, AND ORIENTATION OF THE CONDUITS ENTERING THE HANDHOLE, SEE PLAN SHEETS.
- . CAST IRON HANDHOLE COVERS AND FRAMES SHALL BE PRODUCED BY THE SAME MANUFACTURER AND IN ACCORDANCE WITH MASSDOT SPECIFICATIONS.
- METAL HANDHOLE COVER AND FRAME ARE TO BE BONDED (GROUNDED). DRILL AND TAP FRAME FOR MECHANICAL GROUND LUG CONNECTION. INSTALL A SERVIT POST GROUNDING CONNECTOR SUITABLE TO ACCOMMODATE ONE BARE #6 CONDUCTOR. EXTEND #6 GROUND CONDUCTOR THROUGH FRAME LUG TO BOND COVER. PROVIDE 42" OF SLACK FROM FRAME LUG TO BOND COVER. EXOTHERMICALLY WELD GROUND CONDUCTOR TO COVER.
- 8. FUNCTION DESIGNATION ON THE HANDHOLE SHALL BE LABELED AS FOLLOWS PER NEC ARTICLE 314.30D:

"LIGHTING" FOR LIGHTING CONDUIT



Stantec Consulting Services Inc. 5 Burlington Woods Drive, Suite 300

Burlington MA 01803 U.S.A.
Tel. 781.221.1000
www.stantec.com

Copyright Reserved

The Contractor shall verify and be responsible for all dimensions. DO NOT scale the drawing - any errors or omissions shall be reported to Stantec without delay.

The Copyrights to all designs and drawings are the property of Stantec. Reproduction or use for any purpose other than that authorized by Stantec is forbidden.

Consultants

Logond



Client/Project
City of Salem, MA

Swampscott Road at First Street Roundabout Construction

_____ tle

Salem, MA


LIGHTING DETAILS - PART 2 OF 3

Project No. 179410490

Drawing No.

Scale NOT TO SCALE


Sheet

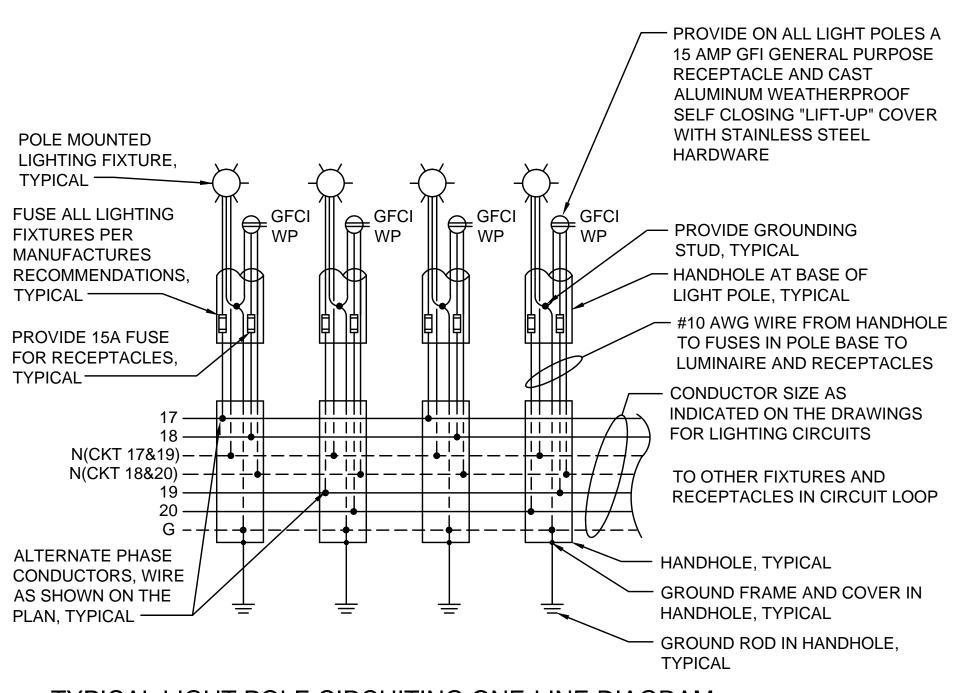

TYPICAL LIGHT POLE CIRCUITING ONE-LINE DIAGRAM

LIGHT POLE WIRING

NOT TO SCALE

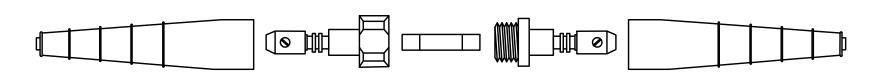


RATING: 600 VOLTS - 20 A	MPS.
FUSE SIZE: 1 1/2" x 13/32" (O.D FERRULE 3/8"
CONNECTOR SIZE: 8 1/2" >	₹ 7/8" O.D.
CONNECTOR TYPE:	FUSE - QUICK DISCONNECT
	SET SCREW TYPE CONNECTION
CONNECTOR MATERIAL:	MOLDED PLASTIC BODY WITH
	RUBBER INSULATING BOOTS.
CONDUCTOR SIZE:	LINE AND LOAD #2 AWG
	THROUGH #12 AWG
REQUIRED FEATURES:	WATERTIGHT NO TAPING OR
	SEALANT REQUIRED
-FUSE HELD IN LOAD SI	DE WHEN CONNECTOR IS DISCONNECTED.
AASHTO COMPLIENT BR	REAKAWAY FUSE HOLDER.
-PROVIDE APPROVED F	USE HOLDER WITH "DUMMY" ROD

FUSE HELD IN LOAD SIDE WHEN CONNECTOR IS DISCONNECTED.


BLANK FUSE FOR NEUTRALS

STRAIGHT THRU CONNECTOR NOT TO SCALE

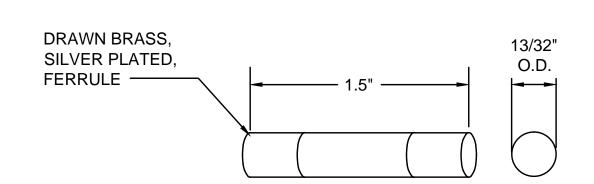

SIZE: MIDGET TYPE: CURRENT LIMITING FUSE VOLTAGE RATING: 120/240 VOLTS USE: PROTECTION OF AREA LIGHTING EQUIPMENT

> FUSES NOT TO SCALE

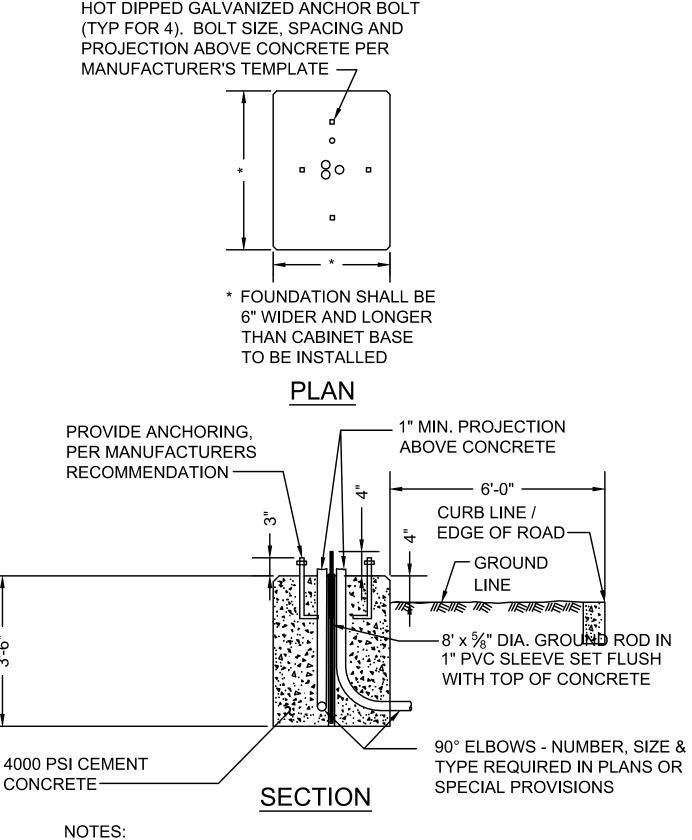


1. ALL EXPOSED EDGES SHALL BE CHAMFERED $^3\!\!4$ ".

- 2. CONTRACTOR SHALL MAINTAIN ACCESS TO BOTH SIDES OF LOAD CENTER. FRONT FOR CUSTOMER ACCESS, BACK FOR UTILITY ACCESS. CONTRACTOR MAY ROTATE LOAD CENTER 90 DEGREES IF NECESSARY TO MAINTAIN ACCESS.
- 3. CONTRACTOR MUST MAINTAIN SIDEWALK CLEARANCE OF 3' MINIMUM AROUND CONCRETE FOUNDATION

CONCRETE FOUNDATION FOR LIGHTING CONTROL CABINET

NOT TO SCALE

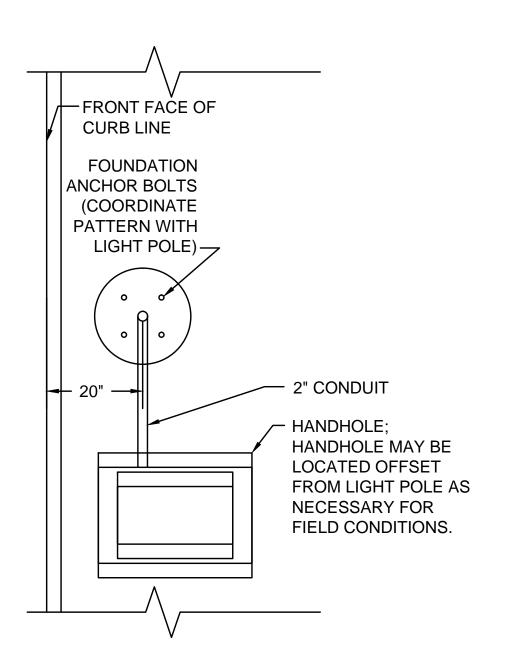

TYPICAL LIGHT POLE AND PULLBOX LAYOUT DETAILS NOT TO SCALE

CONTROLLER SHALL BE PRIME PAINTED THEN FINISH PAINTED WITH ACROLON-BOTTLE GREEN ☐ (STANDARD FEDERAL COLOR #14066) METER SECTION COVER -— METER WINDOW AND COVER — - METER SOCKET - PROVIDE FIELD-INSTALLABLE FIFTH TERMINAL KIT PHOTOCELL - LIFT-OFF SERVICE WINDOW -COVER SALEM LIGHTING HINGED CONTROL DEADFRONT — PANELBOARD - NAMEPLATE **PLACARD FRONT VIEW** SIDE VIEW

NOTES:

PROVIDE MILBANK CP3B51110A22SL1 MODIFIED WITH 100 AMP CONTACTOR, PHOTOCELL TERMINALS, FIFTH
TERMINAL KIT FOR USE WITH RINGLESS METER SOCKETS (COORDINATE WITH ELECTRIC UTILITY FOR
METER SOCKET REQUIREMENTS), MOUNTING BASE, ANCHOR BOLT KIT, GFCI RECEPTACLE, AND INTERNAL
LIGHT FIXTURE OR EQUIVALENT BY MYERS POWER PRODUCTS, OR VIT STRONG BOX.

LIGHTING CONTROL CABINET DETAIL

NOT TO SCALE



Stantec Consulting Services Inc. 5 Burlington Woods Drive, Suite 300 Burlington MA 01803 U.S.A. Tel. 781.221.1000

Copyright Reserved

www.stantec.com

The Contractor shall verify and be responsible for all dimensions. DO NOT scale the drawing - any errors or omissions shall be reported to Stantec without delay.

The Copyrights to all designs and drawings are the property of Stantec. Reproduction or use for any purpose other than that authorized by Stantec is forbidden.

Consultants

Legend

THE COMPLETE DOWNER TO SHARE THE COMPLETE OF T

Client/Project
City of Salem, MA

Swampscott Road at First Street Roundabout Construction

Salem, MA

Drawing No.

LIGHTING DETAILS - PART 3 OF 3

Sheet

Project No. Scale
179410490 NOT TO SCALE

32 of 37

Revision

ORIGINAL SHEET - ARCH D

PANELBOARD LC1-UNSWITCHED

UNSWITCHED LOADS ONLY

BUS: 120/240V, 1PH, 3W, 60HZ

MAIN LUGS ONLY: 100A

VA A: 1055

TOTAL CONNECTED LOAD: 1905 VA

VA B: 850

SHORT CIRCUIT BRACING: CABINET: SURFACE

10-KAIC

PANEL LOCATION: SWAMPSCOTT RD


FEEDER SIZE: 3#2, 1#2-GND GROUND BAR										
LOAD SERVED	HP	VA A	VA B	CKT.	Δ R	CKT NO.	VA A	VA B	HP	LOAD SERVED
MAIN		-		1	$\frac{100A}{60}$	_ 2	50			CONTROL CKT
MAIN			-	3	100A	_ 4		180		GFI RECEPTACLE
SPARE		-		5		<u>4</u> 6	-			SWITCHED LOAD CENTER (BELOW)
SPARE			-	7	100.	8		-		SWITCHED LOAD CENTER (BELOW)
SPARE		-		9		_ 10	-			SPARE
SPACE			-	11]	_ 12		-		SPACE
SPACE		-		13	─	_ 14	-			SPACE
SPACE			-	15		_ 16		-		SPACE

PANELBOARD LC1-SWITCHED

SWITCHED LOADS ONLY

GROUND BAR

LOAD SERVED	HP	VA A	VA B	CKT. NO.		CKT. NO.	VA A	VA B	HP	LOAD SERVED
LUMINIARES - LIGHT POLES 01,03,05		465		17	<u> </u>	18	540			RECEPTACLES - LIGHT POLES 01,03,05
LUMINIARES - LIGHT POLES 02,04			310	19		20		360		RECEPTACLES - LIGHT POLES 02,04
SPARE		ı		21	<u> </u>	22	-			SPARE
SPARE			-	23	— 6	24		-		SPARE
SPACE		-		25		26	-			SPACE
SPACE			-	27	_	28		-		SPACE
SPACE		1		29		30	-			SPACE
SPACE			-	31		32		-		SPACE

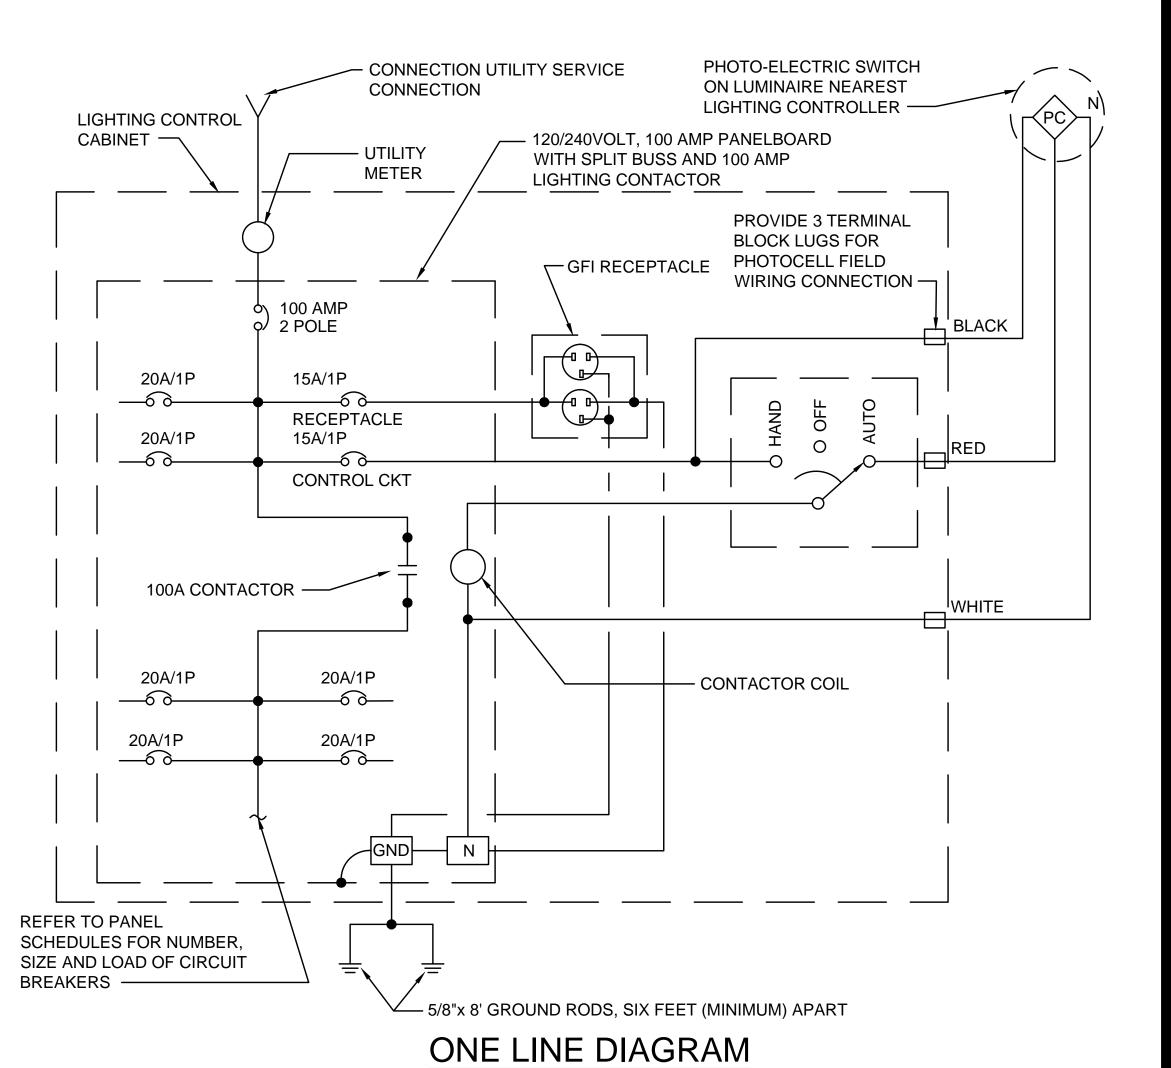

ALL BRANCH C/B:

20 AMP TRIP

UNLESS OTHERWISE NOTED



Stantec Consulting Services Inc. 5 Burlington Woods Drive, Suite 300 Burlington MA 01803 U.S.A. Tel. 781.221.1000 www.stantec.com

Copyright Reserved

The Contractor shall verify and be responsible for all dimensions. DO NOT scale the drawing - any errors or omissions shall be reported to The Copyrights to all designs and drawings are the property of Stantec. Reproduction or use for any purpose other than that authorized by Stantec is forbidden.

Consultants

File Name: lighting_details.dwg Permit-Seal



Client/Project City of Salem, MA


Swampscott Road at First Street Roundabout Construction Salem, MA

LIGHTING PANEL SCHEDULES AND ONE LINE RISER DIAGRAM

Scale Project No. NOT TO SCALE 179410490 Drawing No.

ORIGINAL SHEET - ARCH D

33 of 37

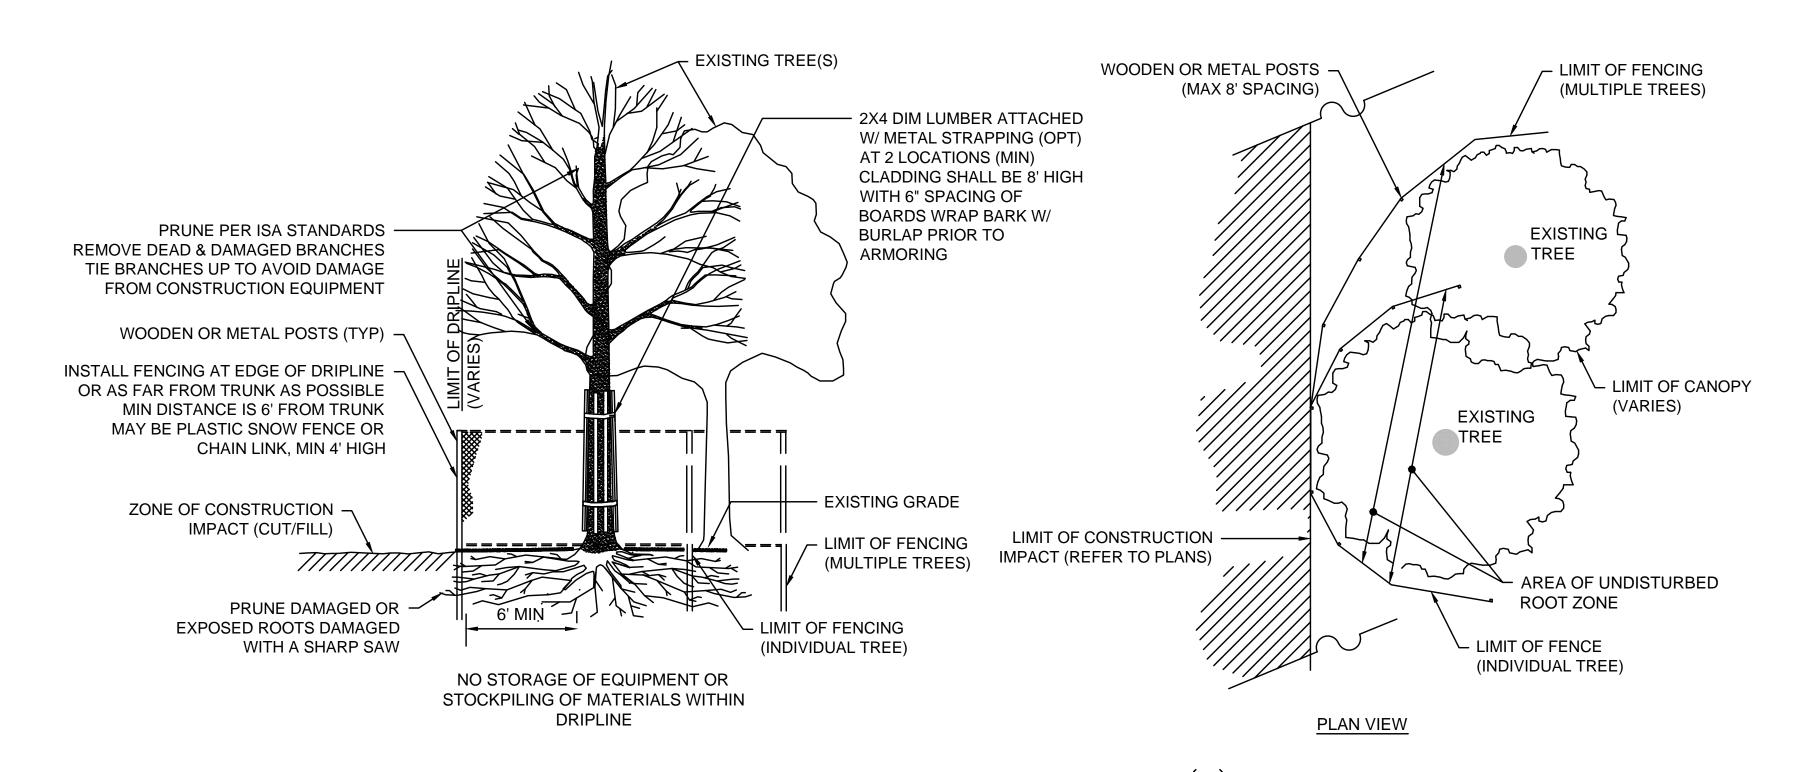

TREE PROTECTION - EXISTING TREE(S)
NOT TO SCALE

GEOTEXTILE SKIRT

48"

36"

CATCH BASIN

GRATE

24"

OVERFLOW

PROVIDE A 3 FT MINIMUM

OVERLAP AT ENDS OF TUBES TO

JOIN IN A CONTINUOUS BARRIER

AND MINIMIZE UNIMPEDED FLOW.

STAKE JOINING TUBES SNUGLY

SECURE ENDS OF TUBES WITH

STAKES SPACED 18 IN APART

THROUGH TOPS OF TUBES.

AGAINST EACH OTHER TO

BETWEEN THEM.

- UNTREATED HARDWOOD

— LOOSE COMPOST LAYER

- COMPOST FILTER TUBE (TYP)

STAKE (TYP)

PREVENT UNFILTERED FLOW

NOTE:
USE TWO SILT SACKS AT DOUBLE GRATE
CATCH BASINS

SILT SACK FOR SEDIMENT CONTROL

NOT TO SCALE

- COMPOST FILTER TUBE MINIMUM 12 INCHES IN DIAMETER WITH AN EFFECTIVE HEIGHT OF 9.5 INCHES.

TUBES FOR COMPOST FILTERS SHALL BE JUTE MESH OR APPROVED BIODEGRADABLE MATERIAL, HOWEVER PHOTO-BIODEGRADABLE FABRIC SHALL BE REMOVED AT END OF CONTRACT.

TAMP TUBES IN PLACE TO ENSURE GOOD CONTACT WITH SOIL SURFACE, IT IS NOT NECESSARY TO TRENCH TUBES INTO EXISTING GRADE.

COMPOST TUBES SHALL BE STAKED OR LEANED AGAINST SUPPORTS (TREES, CINDER BLOCKS) ON SLOPES 2:1 OR GREATER.

WHERE NECESSARY, STAKING SHALL BE MIN. 1 INCH X 1 INCH X 3 FEET UNTREATED HARDWOOD STAKES, UP TO 5 FEET APART OR AS REQUIRED TO SECURE TUBES IN PLACE. TUBES SHALL BE STAKED ACCORDING TO MANUFACTURERS RECOMMENDATIONS.

- UNDISTURBED SOIL & VEGETATION. TUBES SHALL BE PLACED AS CLOSE TO LIMITS OF SOIL DISTURBANCE AS POSSIBLE.

LIMIT OF WORK

SINGLE COMPOST FILTER TUBE DETAIL

NOT TO SCALE

PLAN VIEW - JOIN DETAIL

3.0 FT MIN

DIRECTION OF FLOW



- 1. PROVIDE A MINIMUM TUBE DIAMETER OF 12 INCHES FOR SLOPES UP TO 50 FEET IN LENGTH WITH A SLOPE RATIO OF 3H:1V OR STEEPER. LONGER SLOPES OF 3H:1V MAY REQUIRE LARGER TUBE DIAMETER OR ADDITIONAL COURSING OF FILTER TUBES TO CREATE A FILTER BERM. REFER TO MANUFACTURER'S RECOMMENDATIONS FOR SITUATIONS WITH LONGER OR STEEPER SLOPES.
- 2. INSTALL TUBES ALONG CONTOURS AND PERPENDICULAR TO SHEET OR CONCENTRATED FLOW.
- 3. TUBE LOCATION MAY BE SHIFTED TO ADJUST TO LANDSCAPE FEATURES, BUT SHALL PROTECT UNDISTURBED AREA AND VEGETATION TO MAXIMUM EXTENT POSSIBLE.
- 4. DO NOT INSTALL IN PERENNIAL,
- EPHEMERAL OR INTERMITTENT STREAMS.
 5. ADDITIONAL TUBES SHALL BE USED AS
- REQUIRED BY THE ENGINEER.

 6. ADDITIONAL STAKING SHALL BE USED AS REQUIRED BY THE ENGINEER.

TUBES MAY BE PLACED ON THE TUBES CAN BE **UPHILL SIDE OF** PLACED DIRECTLY WELL- ANCHORED, ON EXISTING STATIONARY PAVEMENT WHEN **EXISTING** FEATURES SUCH AS NECESSARY. TREE **EXISTING TREES IN** LIEU OF STAKING. DIRECTION OF FLOW EXISTING HEADWALL OR OTHER OBSTACLE **STREAM** TUBES MAY BE SLEEVED (ONE INSERTED INTO ANOTHER) OR PROVIDE A 3 FT MINIMUM OVERLAP AT ENDS OF TUBES TO JOIN IN A 3.0 FT **DIRECTION OF FLOW CONTINUOUS BARRIER CURVE ENDS UPHILL** TO PREVENT - UNTREATED HARDWOOD **DIVERSION OF** STAKES (TYP) UNFILTERED RUN-OFF. PLAN VIEW



5 Burlington Woods Drive, Suite 300
Burlington MA 01803 U.S.A.
Tel. 781.221.1000

Copyright Reserved

www.stantec.com

The Contractor shall verify and be responsible for all dimensions. DO NOT scale the drawing - any errors or omissions shall be reported to Stantec without delay.

The Copyrights to all designs and drawings are the property of Stantec. Reproduction or use for any purpose other than that authorized by Stantec is forbidden.

Consultants

Legend

Notes

CONDITION OF THE PROPERTY OF T

Client/Project
City of Salem, MA

Swampscott Road at First Street Roundabout Construction Salem, MA

_____ le

CONSTRUCTION DETAILS - PART 1

Project No.
Scale
NOT TO SCALE


Drawing No.
Sheet

34 of 37

Revision

ORIGINAL SHEET - ARCH D


DIRECTION OF FLOW

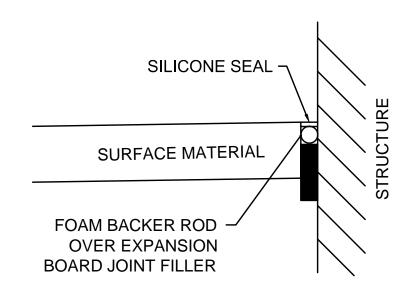


NOTES:

- 1. THIS DETAIL SHALL BE USED ANYWHERE A PROPOSED CEM CONC OR HMA SURFACE ABUTS THE EDGE OF A STRUCTURE.
- 2. WORK OF INSTALLING EXPANSION JOINT AND SILICONE CAULKING IS INCIDENTAL TO THE PROPOSED CONCRETE AND HMA WORK FOR ALL LOCATIONS.
- 3. SILICONE SEALER SHALL MEET ASTM D5893 STANDARD.


EXPANSION JOINT NOT TO SCALE

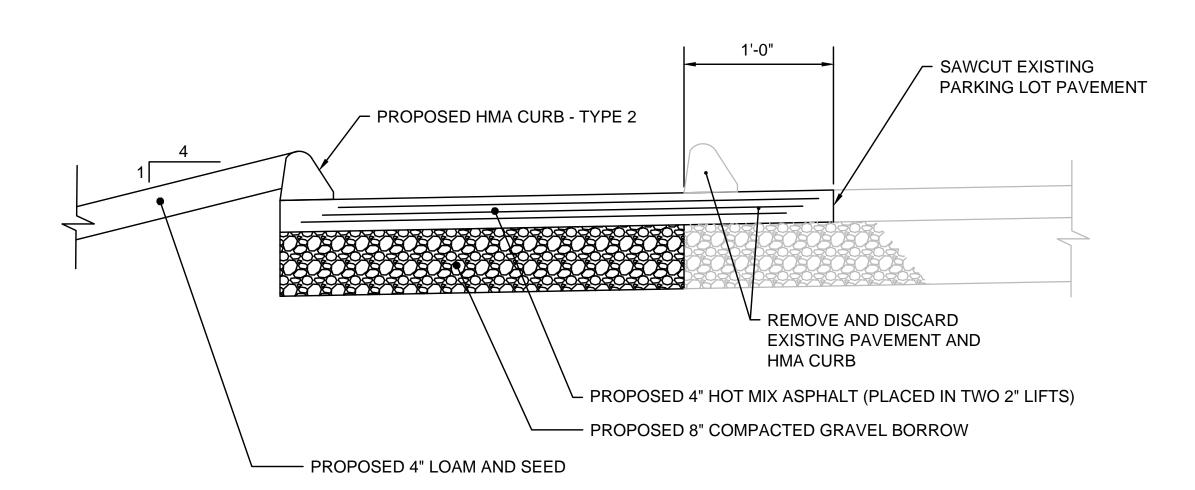


PARKING LOT EXPANSION DETAIL NOT TO SCALE

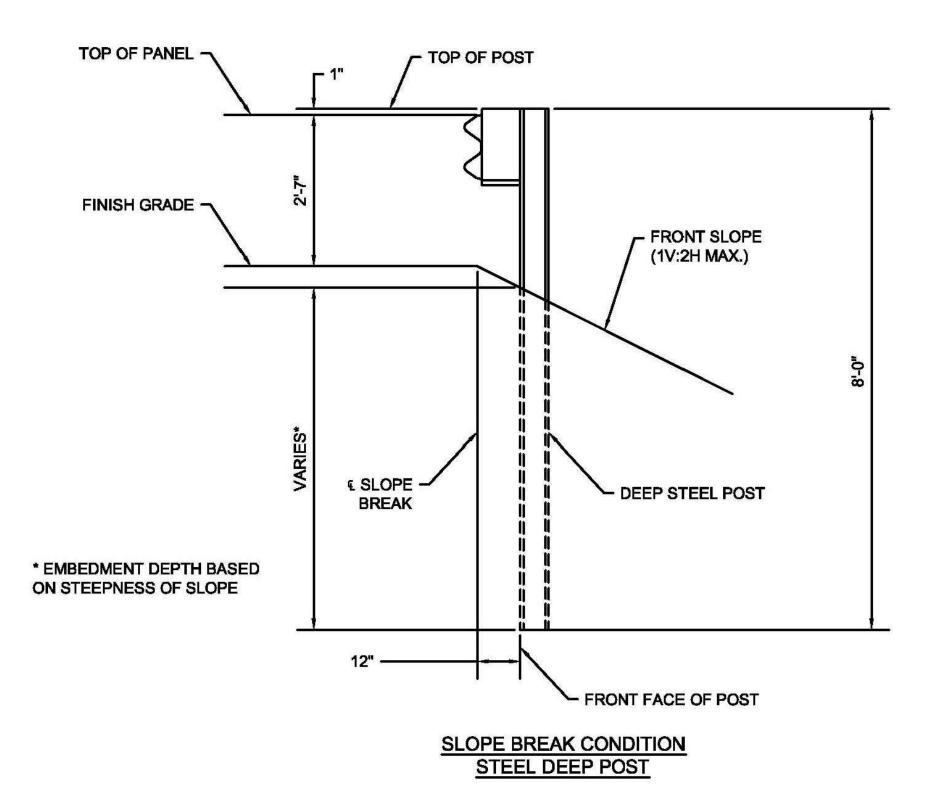

DETAIL 400.1.5: GUARDRAIL MOUNTING HEIGHTS & POST DEPTHS NOT TO SCALE

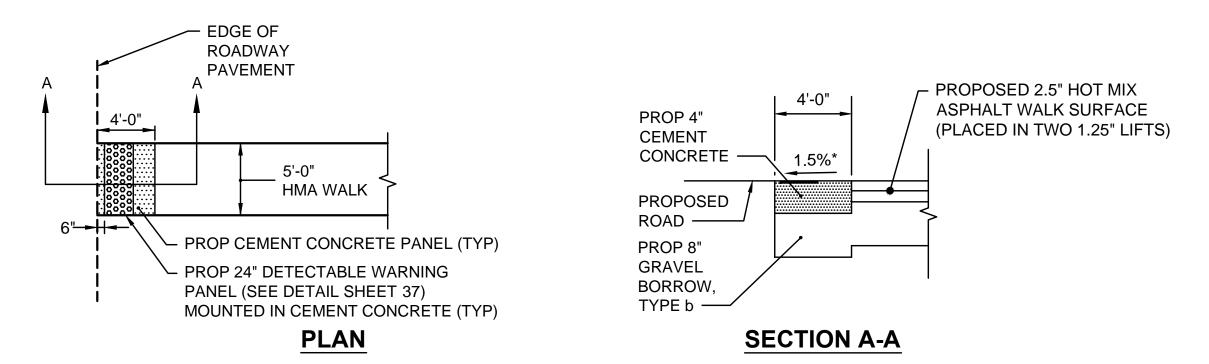

WITHIN HMA WALK

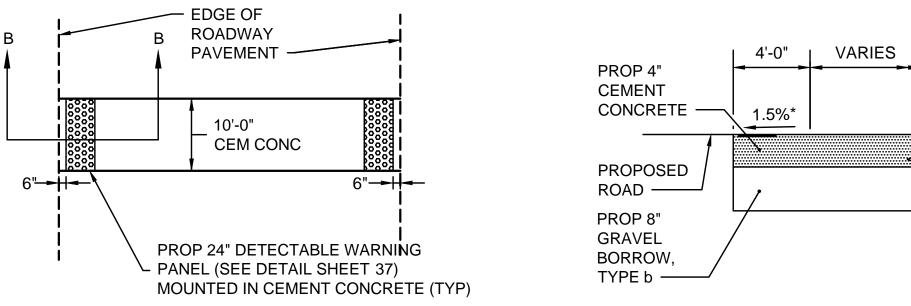

PLAN

SECTION B-B

WITHIN SPLITTER ISLAND

NOTES

- 1. ALL DETECTABLE WARNING PANELS (PROJECT WIDE) SHALL BE MOUNTED IN CEMENT CONCRETE.
- 2. DETECTABLE WARNING PANELS SHALL CONFORM TO MASSDOT STANDARD DETAIL E107.6.5.

DETECTABLE WARNING PANEL MOUNTED IN CEMENT CONCRETE PANEL

NOT TO SCALE



Stantec Consulting Services Inc. 5 Burlington Woods Drive, Suite 300

Burlington MA 01803 U.S.A. Tel. 781.221.1000 www.stantec.com

Copyright Reserved

The Contractor shall verify and be responsible for all dimensions. DO NOT scale the drawing - any errors or omissions shall be reported to Stantec without delay.

The Copyrights to all designs and drawings are the property of Stantec. Reproduction or use for any purpose other than that authorized by Stantec is forbidden.

Consultants

Legend

Revision

By Appd. YY.MM.

File Name: construction_details.dwg SEA RAA SEA 17.09.0

Dwn. Chkd. Dsgn. YY.MM.

Permit-Seal



Client/Project
City of Salem, MA

Swampscott Road at First Street Roundabout Construction


Roundabout C Salem, MA

CONSTRUCTION DETAILS - PART 2

Project No.
Scale
NOT TO SCALE

Drawing No.
Sheet Revision


35 of 37

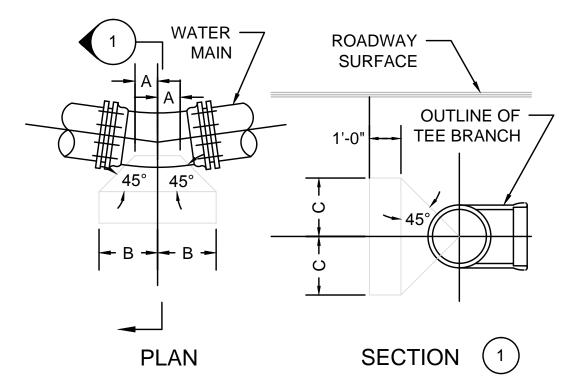


HORIZONTAL THRUST BLOCK SCHEDULE TABLE OF DIMENSIONS IN INCHES							
	<u>A</u>	<u>B</u>	<u>C</u>				
6" BEND							
1/32, 1/16	6	10	10				
1/8	6	14	14				
1/4	9	19	19				
10" BEND							
1/32, 1/16	6	14	14				
1/8	6	20	20				
1/4	9	27	27				
12" BEND							
1/32, 1/16	6	13	13				
1/8	6	18	18				
1/4	9	26	26				
20" BEND							
1/32, 1/16	12	22	22				
1/8	12	32	32				
1/4	12	42	42				
PLUG, TEE (BRANCH)							
6"	6	15	15				
8"	9	16	16				
12"	9	23	23				
16"	12	30	27				
20"	12	36	36				


- 1. REFER TO SPECIFICATIONS FOR MATERIAL REQUIREMENTS
- 2. SUBJECT TO FIELD MODIFICATION BY ENGINEER

THRUST BLOCK DETAIL NOT TO SCALE

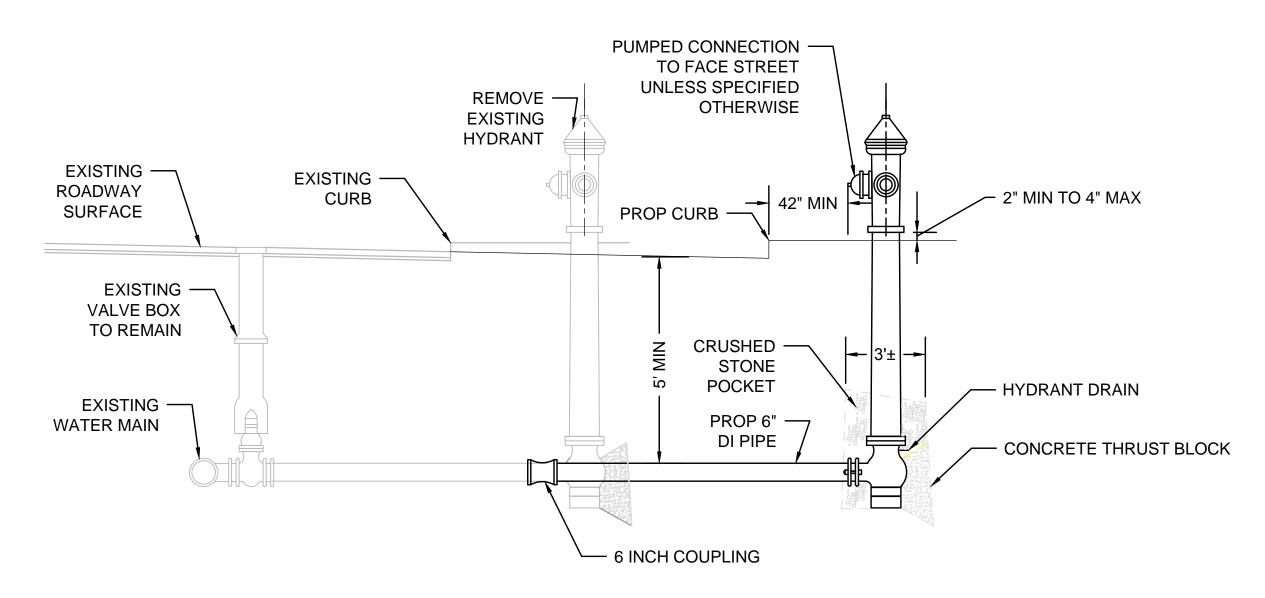


FIRE HYDRANT AT EXISTING CONNECTION NOT TO SCALE

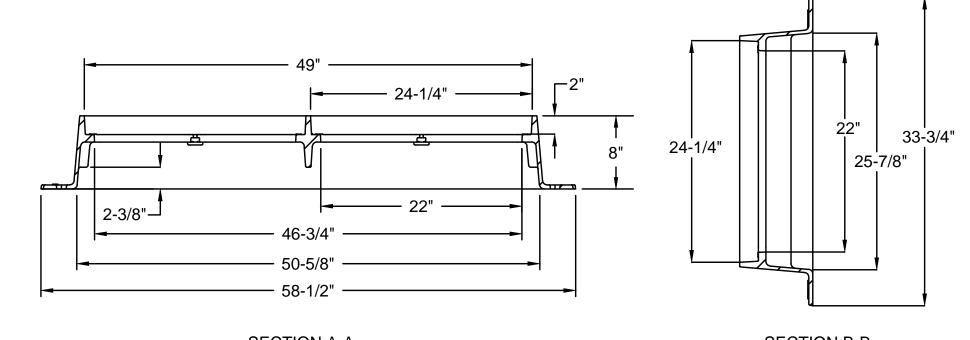

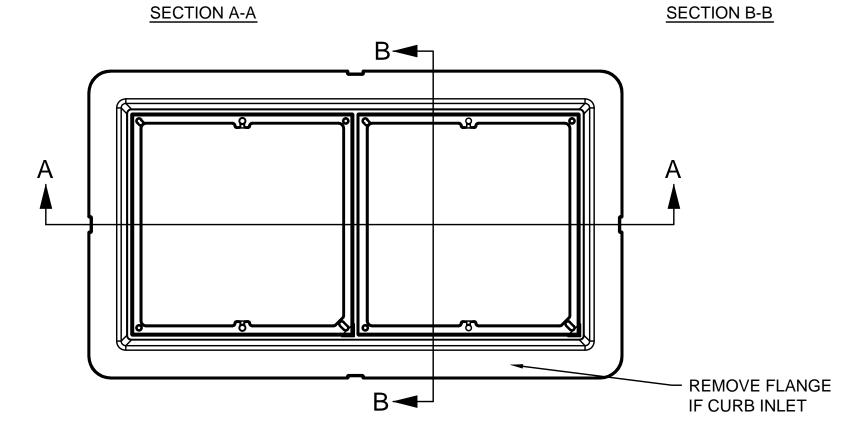

NOTE: DOUBLE FRAME AND GRATE SHALL BE DESIGNED FOR HS-20 LOADING

DOUBLE FRAME NOT TO SCALE

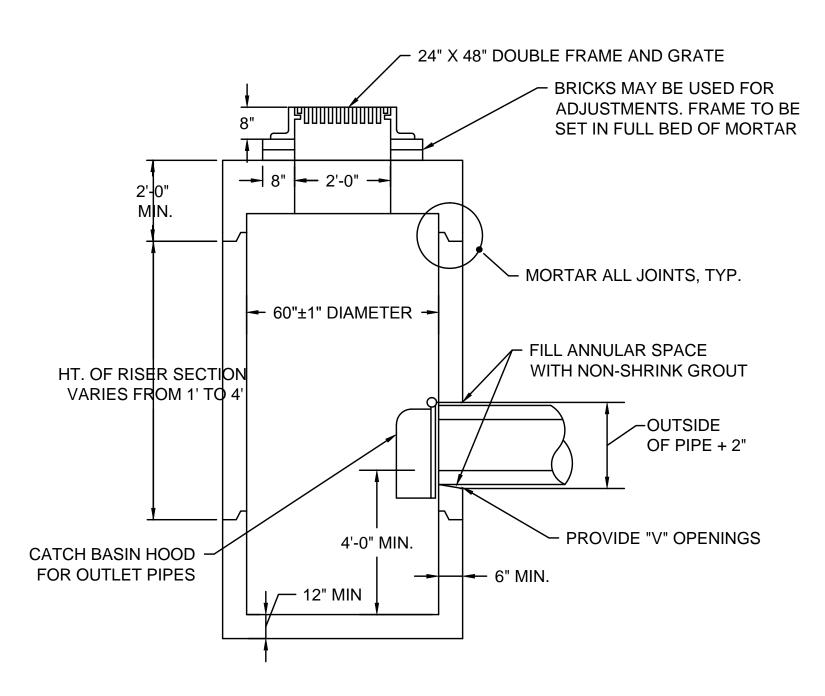

NOTE:

- 1. MIN 0.12 SQ. IN STEEL PER VERTICAL FOOT, PLACED ACCORDING TO
- AASHTO DESIGNATION M199, TYPICAL ALL SIDES
- 2. ALL SECTIONS SHALL BE DESIGNED FOR HS-20 LOADING
- 3. ALL GRATES SHALL BE ADA COMPLIANT.

SPECIAL CATCH BASIN - DOUBLE GRATE NOT TO SCALE



Stantec Consulting Services Inc. 5 Burlington Woods Drive, Suite 300 Burlington MA 01803 U.S.A. Tel. 781.221.1000 www.stantec.com

Copyright Reserved

The Contractor shall verify and be responsible for all dimensions. DO NOT scale the drawing - any errors or omissions shall be reported to The Copyrights to all designs and drawings are the property of Stantec. Reproduction or use for any purpose other than that authorized by Stantec is forbidden.

Consultants

Legend

Revision Appd. YY.MM.DD By Appd. YY.MM.DD

SEA RAA SEA 17.09.06
Dwn. Chkd. Dsgn. YY.MM.DD

Permit-Seal




File Name: construction_details.dwg


Client/Project City of Salem, MA

Swampscott Road at First Street Roundabout Construction Salem, MA


CONSTRUCTION DETAILS - PART 3


Scale Project No. NOT TO SCALE 179410490 Drawing No. Sheet

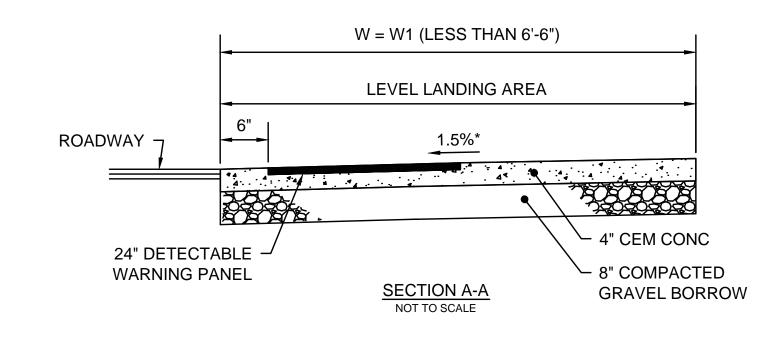

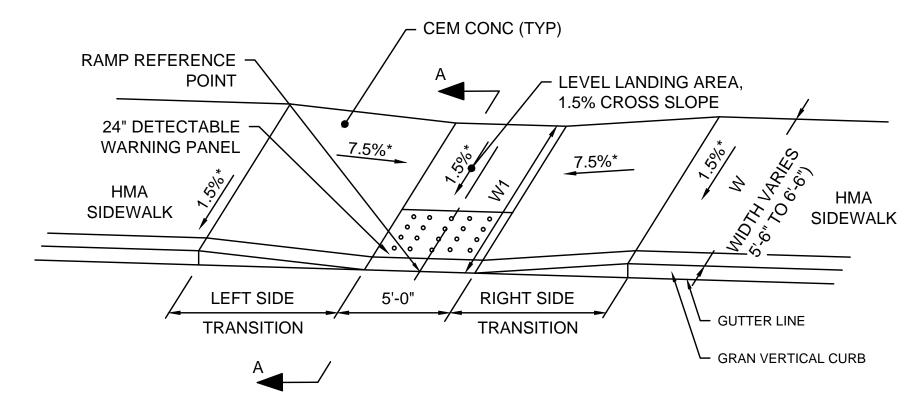

WHEELCHAIR RAMP TYPE A FOR SIDEWALKS LESS THAN 6'-6" NOT TO SCALE

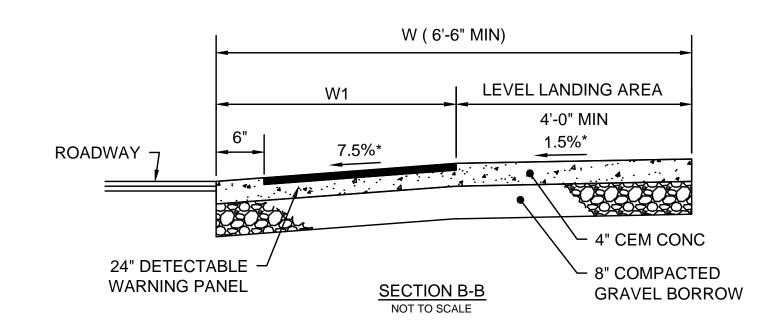


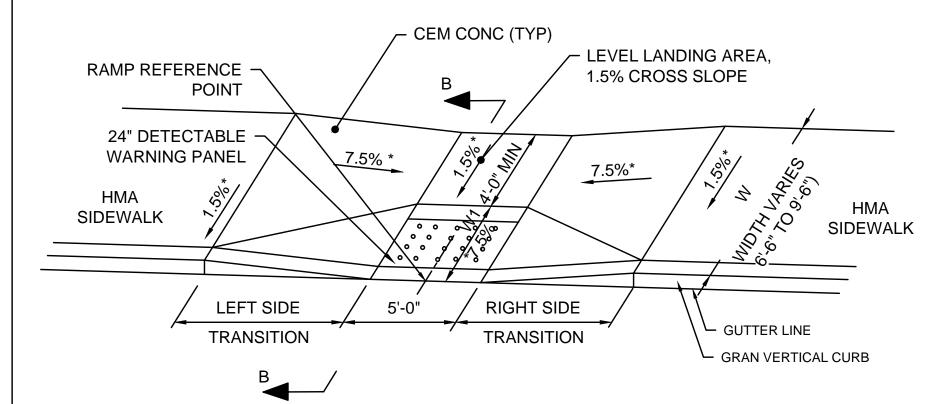


WHEELCHAIR RAMP TYPE B FOR SIDEWALKS 6'-6" TO 12'-0" NOT TO SCALE


WHEELCHAIR RAMPS WIDTH OF RAMP ROADWAY TRANSITION LENGTH WIDTH OF RAMP REFERENCE POINT DEPTH OF LENGTH SIDEWALK **GUTTER** WCR# TYPE LEVEL LANDING LEFT SIDE SLOPE RIGHT SIDE (W1) **OPENING** OFFSET BASELINE STATION FIRST STREET 102+47.40 21.25' LT 6'-0" NA 3.19% 6'-6" 14'-0" 5.00' 6'-0" FIRST STREET 102+45.05 19.79' RT **VARIES** 2'-0" 4'-6" TO 5'-0" 3.35% 14'-0" 5.00' SWAMPSCOTT ROAD 14+24.99 19.82' LT 6'-0" NA 6'-0" 1.45% 9'-0" 6'-6" 5.00'

(LEFT SIDE\RIGHT SIDE DETERMINED WHEN STANDING IN ROADWAY LOOKING AT RAMP OR DRIVEWAY)

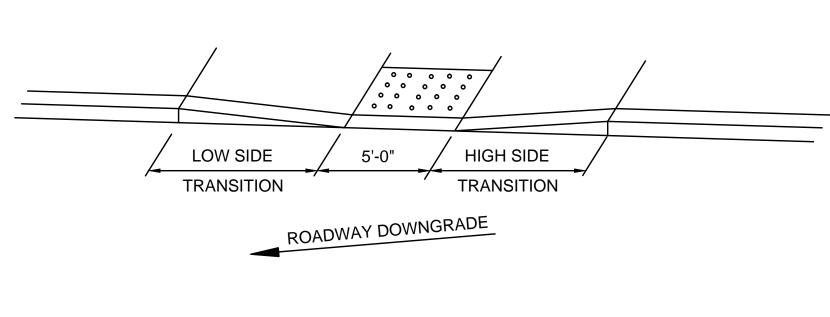

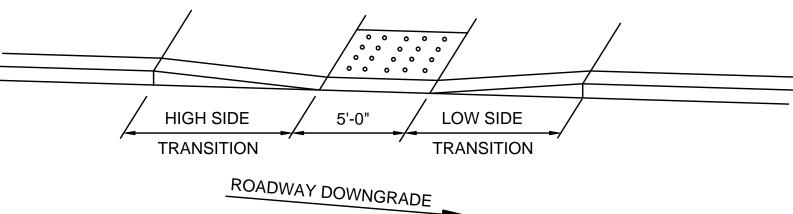

TRANSITION LENGTH PROFILE GRADE NOT TO SCALE

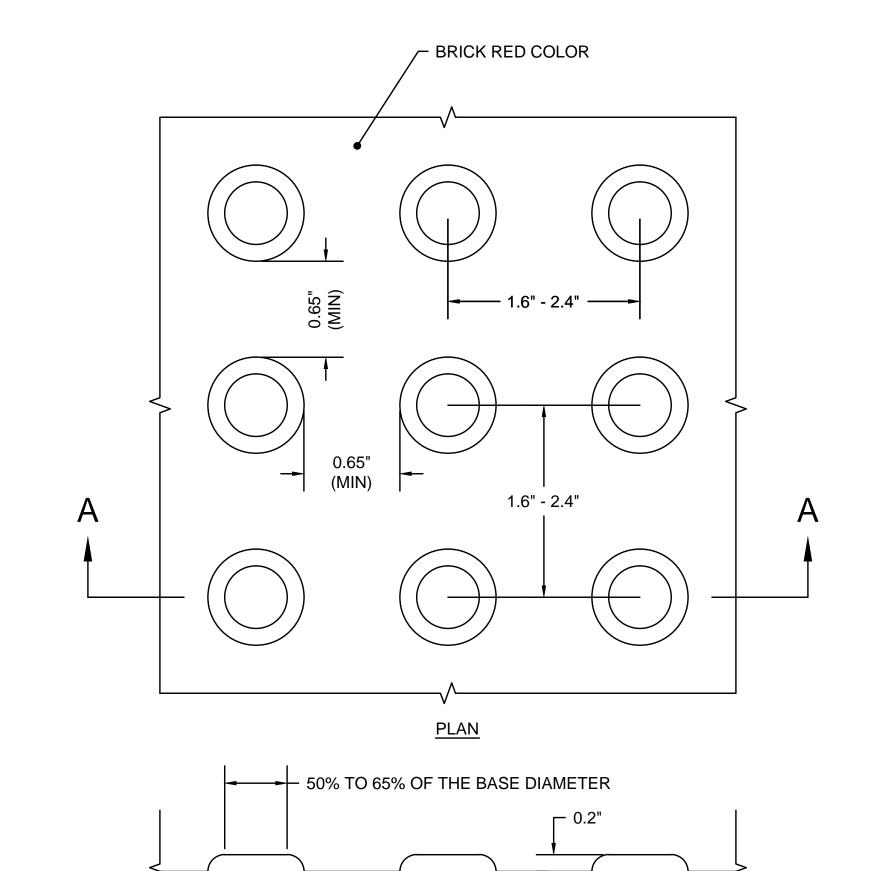

DETECTABLE WARNING PANEL DETAIL
NOT TO SCALE

SECTION A-A

0.9" - 1.4"



Stantec Consulting Services Inc. 5 Burlington Woods Drive, Suite 300 Burlington MA 01803 U.S.A. Tel. 781.221.1000 www.stantec.com

Copyright Reserved

The Contractor shall verify and be responsible for all dimensions. DO NOT scale the drawing - any errors or omissions shall be reported to The Copyrights to all designs and drawings are the property of Stantec. Reproduction or use for any purpose other than that authorized by Stantec is forbidden.

Consultants

Legend

Notes

File Name: construction_details.dwg

Permit-Seal



Client/Project City of Salem, MA

Swampscott Road at First Street Roundabout Construction Salem, MA

WHEELCHAIR RAMP DETAILS

Project No. 179410490

Drawing No.

Scale NOT TO SCALE

Sheet

Revision

ORIGINAL SHEET - ARCH D

37 of 37